
STATE OF CONNECTICUT

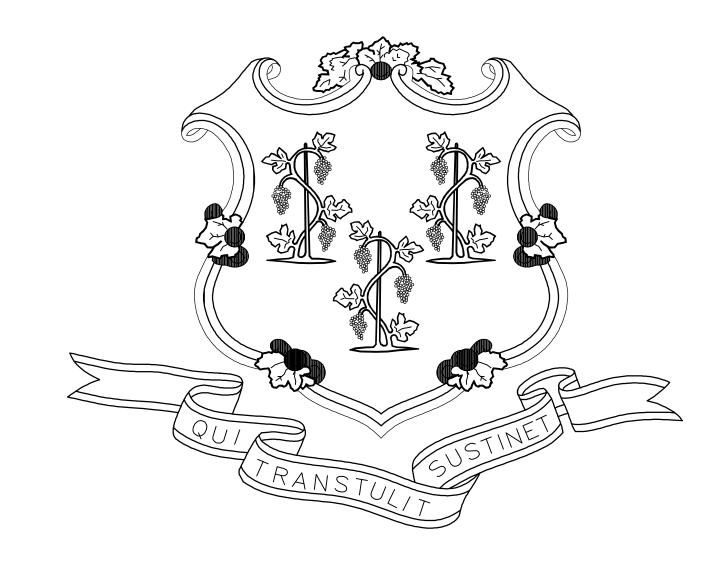

NED LAMONT, GOVERNOR

THROUGH
CAPITAL REGION DEVELOPMENT AUTHORITY
100 COLUMBUS BOULEVARD, SUITE 500
HARTFORD, CT 06103

CHURCH STREET PARKING GARAGE RENOVATIONS AND IMPROVEMENTS HARTFORD, CT

CRDA PROJECT NO. 21-016

STRUCTURAL ENGINEER:



A DIVISION OF DESMAN, INC.

NEW YORK CHICAGO WASHINGTON, D.C. HARTFORD BOSTON CLEVELAND

175 Capital Boulevard, SUITE 402

Rocky Hill, CT 06067

P 860-563-1117: F 860-563-1118


CONTRACT DRAWINGS

BASEMENT LEVEL FLOOR PLAN

R-1.1 FIRST LEVEL FLOOR PLAN SECOND LEVEL FLOOR PLAN **R-1.2 R-1.3** THIRD LEVEL FLOOR PLAN FOURTH LEVEL FLOOR PLAN FIFTH LEVEL FLOOR PLAN SIXTH LEVEL FLOOR PLAN SEVENTH LEVEL FLOOR PLAN **R-2.1** CONCRETE REPAIR DETAILS & SECTIONS CONCRETE REPAIR DETAILS & SECTIONS **R-3.1** MISC. METAL DETAILS & SECTIONS MISC. METAL DETAILS & SECTIONS

WATERPROOFING DETAILS & SECTIONS

RELEASED FOR BID APRIL 2021

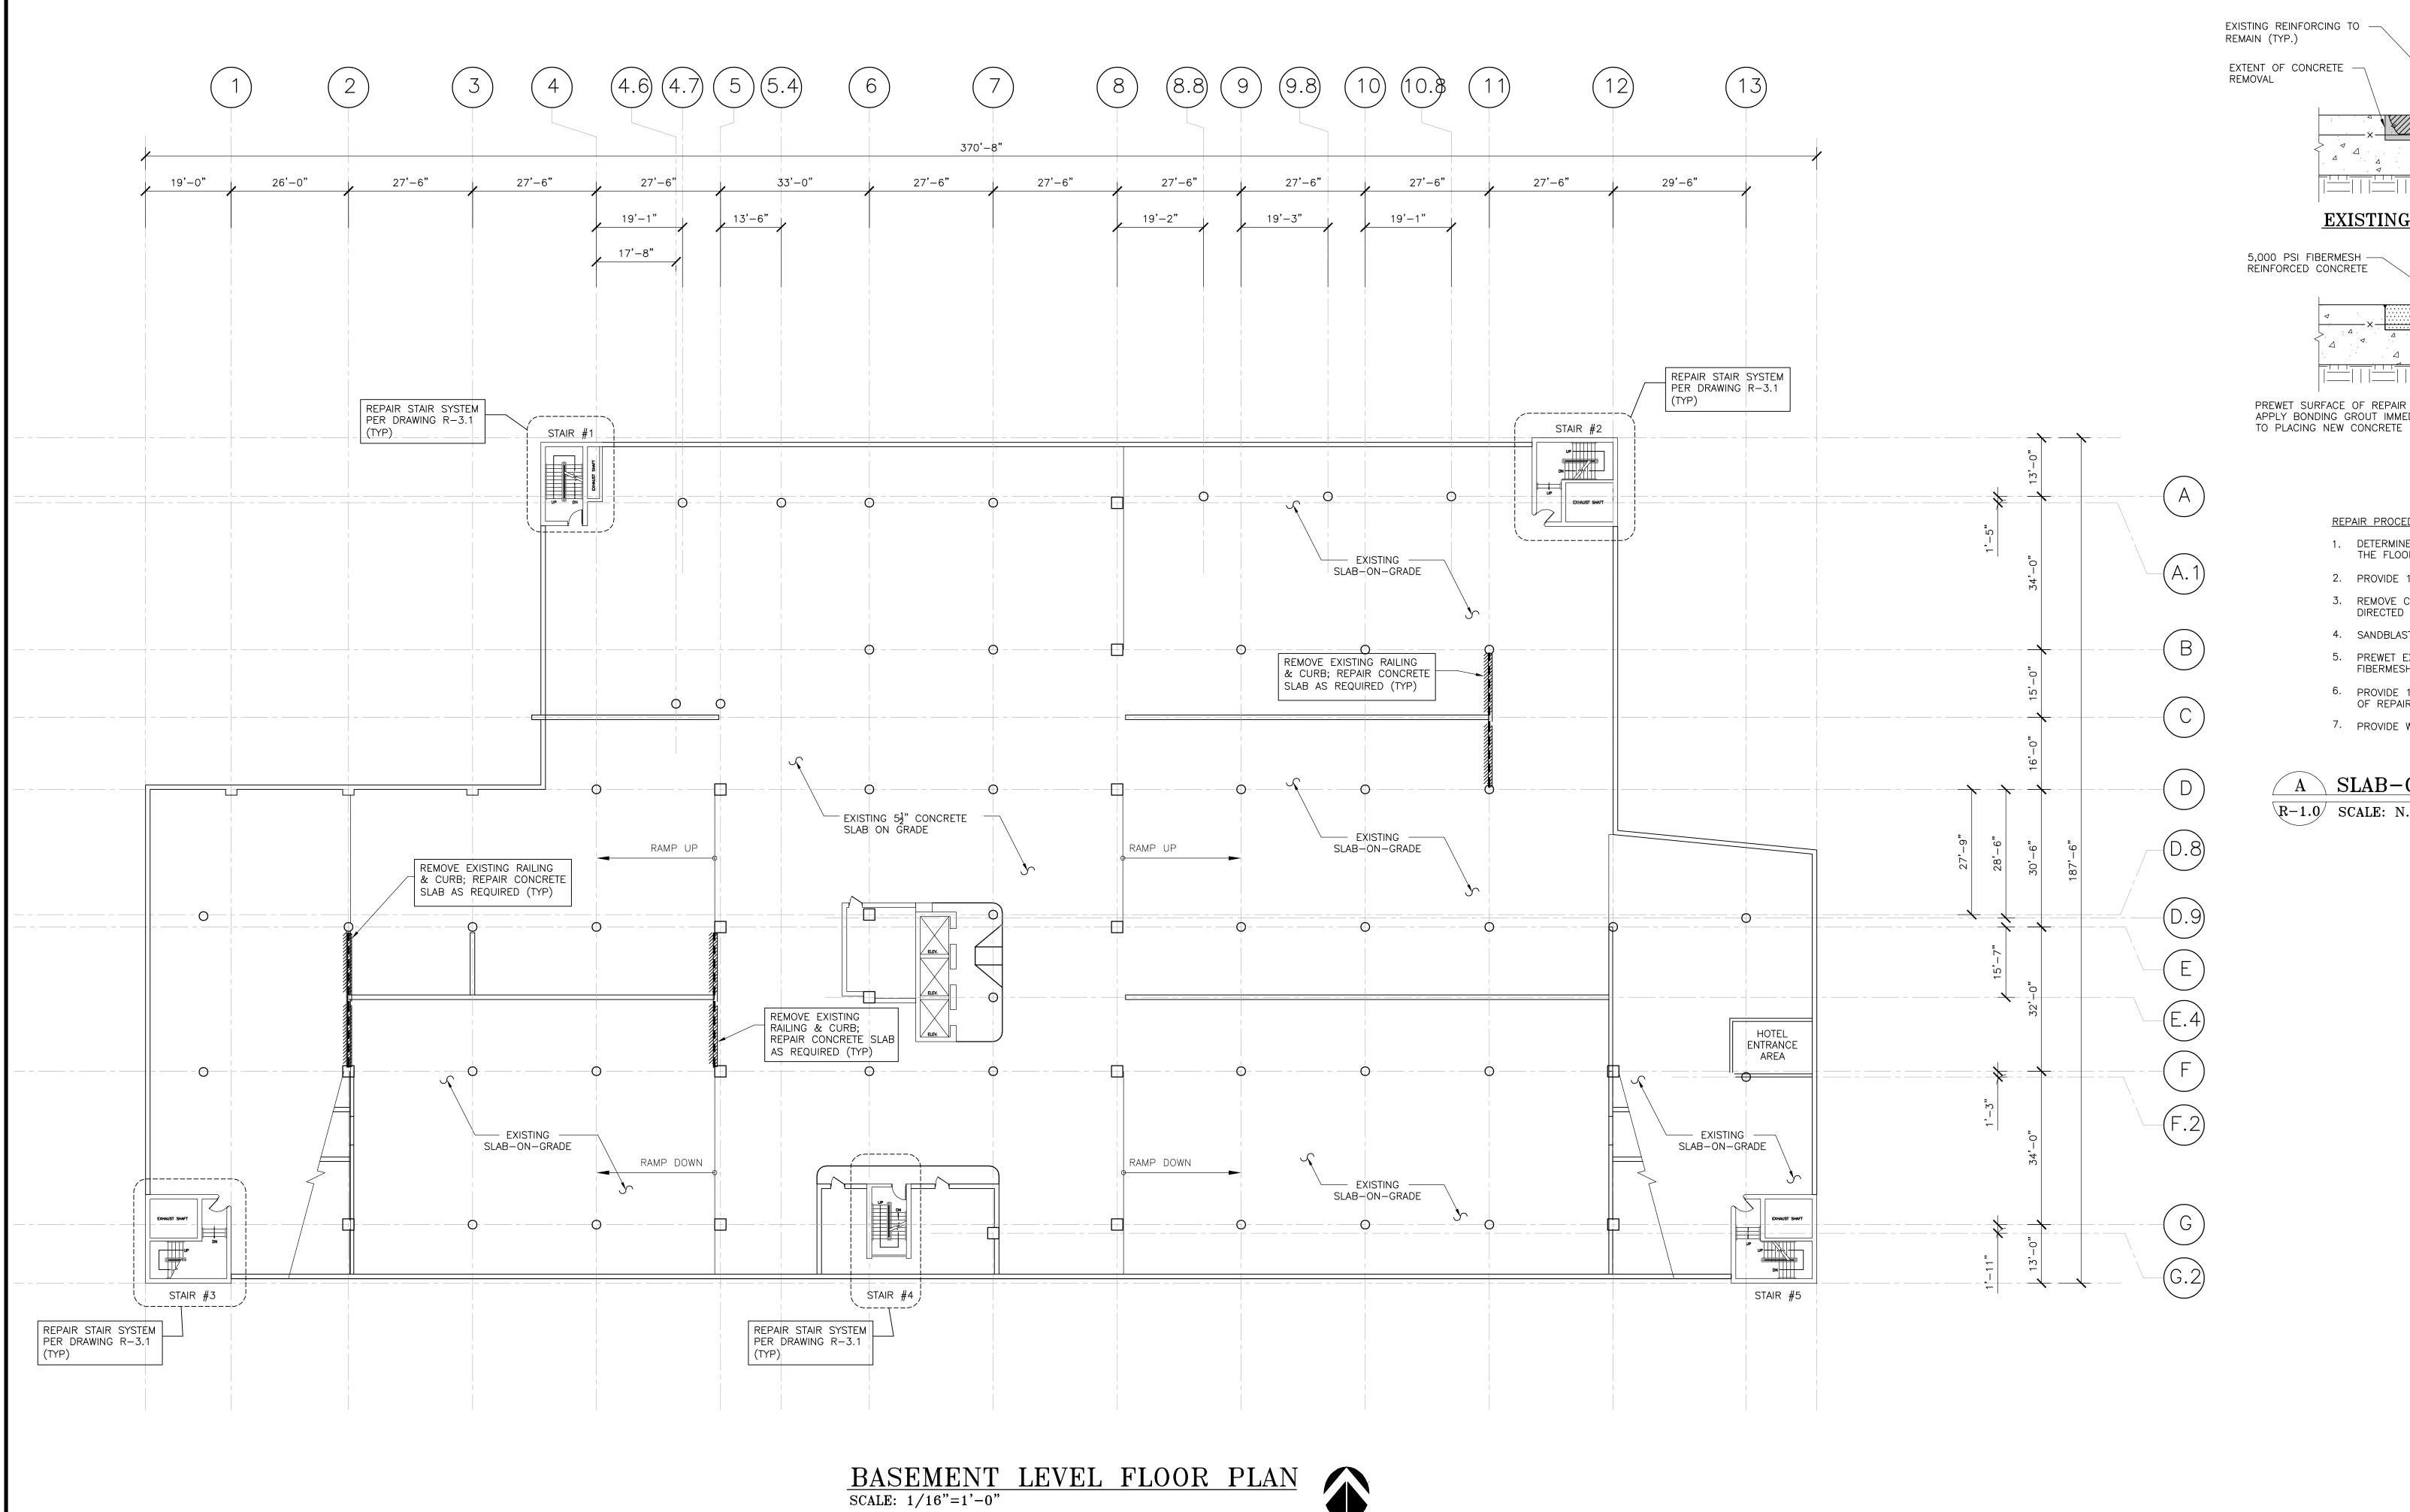





12

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- 3. FOR CONCRETE DECK REPAIRS, SEE DRAWINGS R-2.1 & R-2.2. PRIOR TO START OF DEMOLITION AFFECTING A WORK AREA, CONTRACTOR SHALL LOCATE AND IDENTIFY ALL EXISTING, EMBEDDED POST—TENSION TENDONS (REGARDING THE UPPER LEVELS), BY APPROPRIATE METHODS (GROUND PENETRATING RADAR, OR APPROVED METHOD), AS APPROVED BY ENGINEER/OWNER. UPON LOCATING THE TENDONS, CONTRACTOR SHALL MARK THE LOCATIONS FOR VERIFICATION BY THE ENGINEER. DEMOLITION ACTIVITIES, AS REQUIRED FOR DESIGNATED CONCRETE REPAIRS, SHALL NOT BE STARTED UNTIL LOCATIONS OF TENDONS HAVE BEEN VERIFIED BY THE ENGINEER. IF DEMOLITION ACTIVITIES ARE STARTED BEFORE ENGINEER VERIFIES THE LOCATED TENDONS AS IDENTIFIED BY THE CONTRACTOR, CONTRACTOR SHALL PROCEED AT CONTRACTOR'S OWN RISK. SHOULD POST—TENSION TENDONS BE DAMAGED (OR ANY OTHER APPLICABLE UNFORESEEN CONDITIONS ARISE) WHILE CONTRACTOR IS PERFORMING AT CONTRACTOR'S OWN RISK, THEN CONTRACTOR SHALL REPAIR ALL DAMAGED TENDONS OR PERFORM OTHER APPLICABLE WORK (INCLUSIVE OF ANY COSTS ASSOCIATED WITH PROVISION OF SHORING, TRAFFIC CONTROL, ETC.) AT NO ADDITIONAL COST TO OWNER.
- 4. THE SUPPORTED CONCRETE SLAB SHALL BE SHORED AS REQUIRED PRIOR TO THE START OF CONCRETE DEMOLITION, SHORING MUST BE DESIGNED AND STAMPED BY A PROFESSIONAL ENGINEER REGISTERED IN THE STATE OF CONNECTICUT. SHOP DRAWINGS OF THE SHORING DESIGN SHALL BE SUBMITTED TO THE ENGINEER FOR REVIEW AND APPROVAL PRIOR TO CONC. REMOVAL.
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- 12. FOLLOWING COMPLETION OF MEMBRANE WORK, CONTRACTOR SHALL APPLY NEW MARKINGS FOR ALL PARKING STALLS, DIRECTIONAL ARROWS, CROSSWALKS, CURBS, CENTERLINES, TEXT AND OTHER TRAFFIC MARKINGS LOCATED THROUGHOUT THE GARAGE. APPLICATION OF STRIPING SHALL TYPICALLY BE PERFORMED TO MATCH PRE-EXISTING CONDITIONS OR AS OTHERWISE DIRECTED BY THE ENGINEER. HOWEVER ALL HANDICAP PARKING STALLS SHALL BE UPDATED ACCORDINGLY PER CURRENT REQUIREMENTS AND QUANTITY/LOCATION OF HANDICAP PARKING STALLS SHALL BE VERIFIED PRIOR TO START OF WORK; ALL CURBINGS SHALL BE PAINTED, BOTH THOSE CURRENTLY PAINTED AND THOSE NOT. ANY AND ALL CONFLICTING MARKINGS SHALL BE REMOVED IN THEIR ENTIRETY BY APPROVED METHOD. OWNER/ENGINEER SHALL BE REQUIRED TO REVIEW STRIPING LAYOUT PRIOR TO THIS WORK BEING PERFORMED.



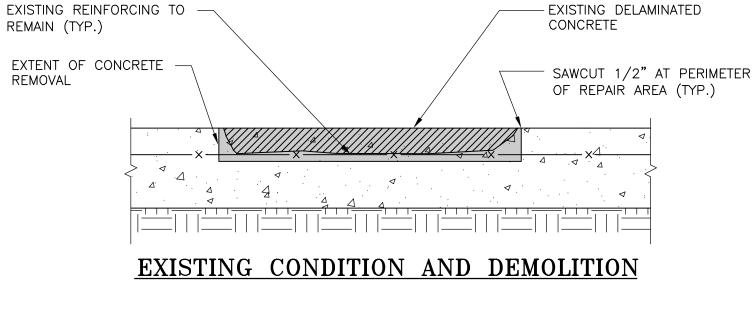

REPAIRED CONDITION

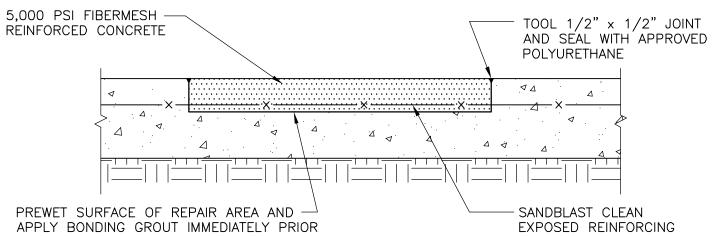
REPAIR PROCEDURE

1. DETERMINE EXACT LOCATION OF DETERIORATED CONCRETE BY SOUNDING THE FLOOR SLAB IN THE PRESENCE OF THE ENGINEER.


BARS (TYP.)

- 2. PROVIDE 1/2" DEEP SAWCUT AT PERIMETER OF REPAIR AREA.
- 3. REMOVE CONCRETE TO SPECIFIED DEPTH AS SHOWN ON DETAIL AND AS DIRECTED BY THE ENGINEER IN THE FIELD USING CHIPPING HAMMERS.
- 4. SANDBLAST CLEAN EXISTING REINFORCING.
- 5. PREWET EXISTING CONCRETE AS REQUIRED AND PLACE NEW 5,000 PSI FIBERMESH CONCRETE.
- 6. PROVIDE 1/2" x 1/2" TOOLED JOINT WITH SEALANT AROUND PERIPHERY OF REPAIR AREA.
- 7. PROVIDE WET CURE AS PER SPECIFICATIONS.

A SLAB-ON-GRADE CONCRETE REPAIR R-1.0 SCALE: N.T.S.

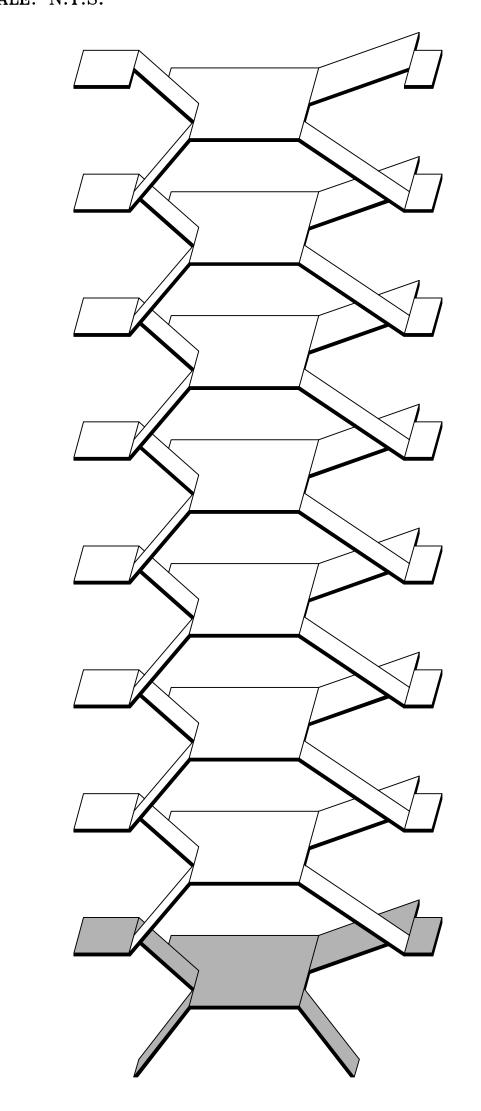

BASEMENT LEVEL FLOOR PLAN Revisions			STATE OF CONNECTICUT CAPITAL REGION DEVELOPMENT AUTHORITY	
No.	Date	Description	Plans Prepared By: DESIGN Management	Date: APRIL 2021 Scale AS NOTED Production Leader
			Project: CHURCH STREET PARKING GARAGE RENOVATIONS & IMPROVEMENTS	Project Manager: - Project Architect: -
			HARTFORD, CONNECTICUT	Peer Reviewer: - Drawing Number
CAD Numb	er:		Project Number: 21-016	R-1

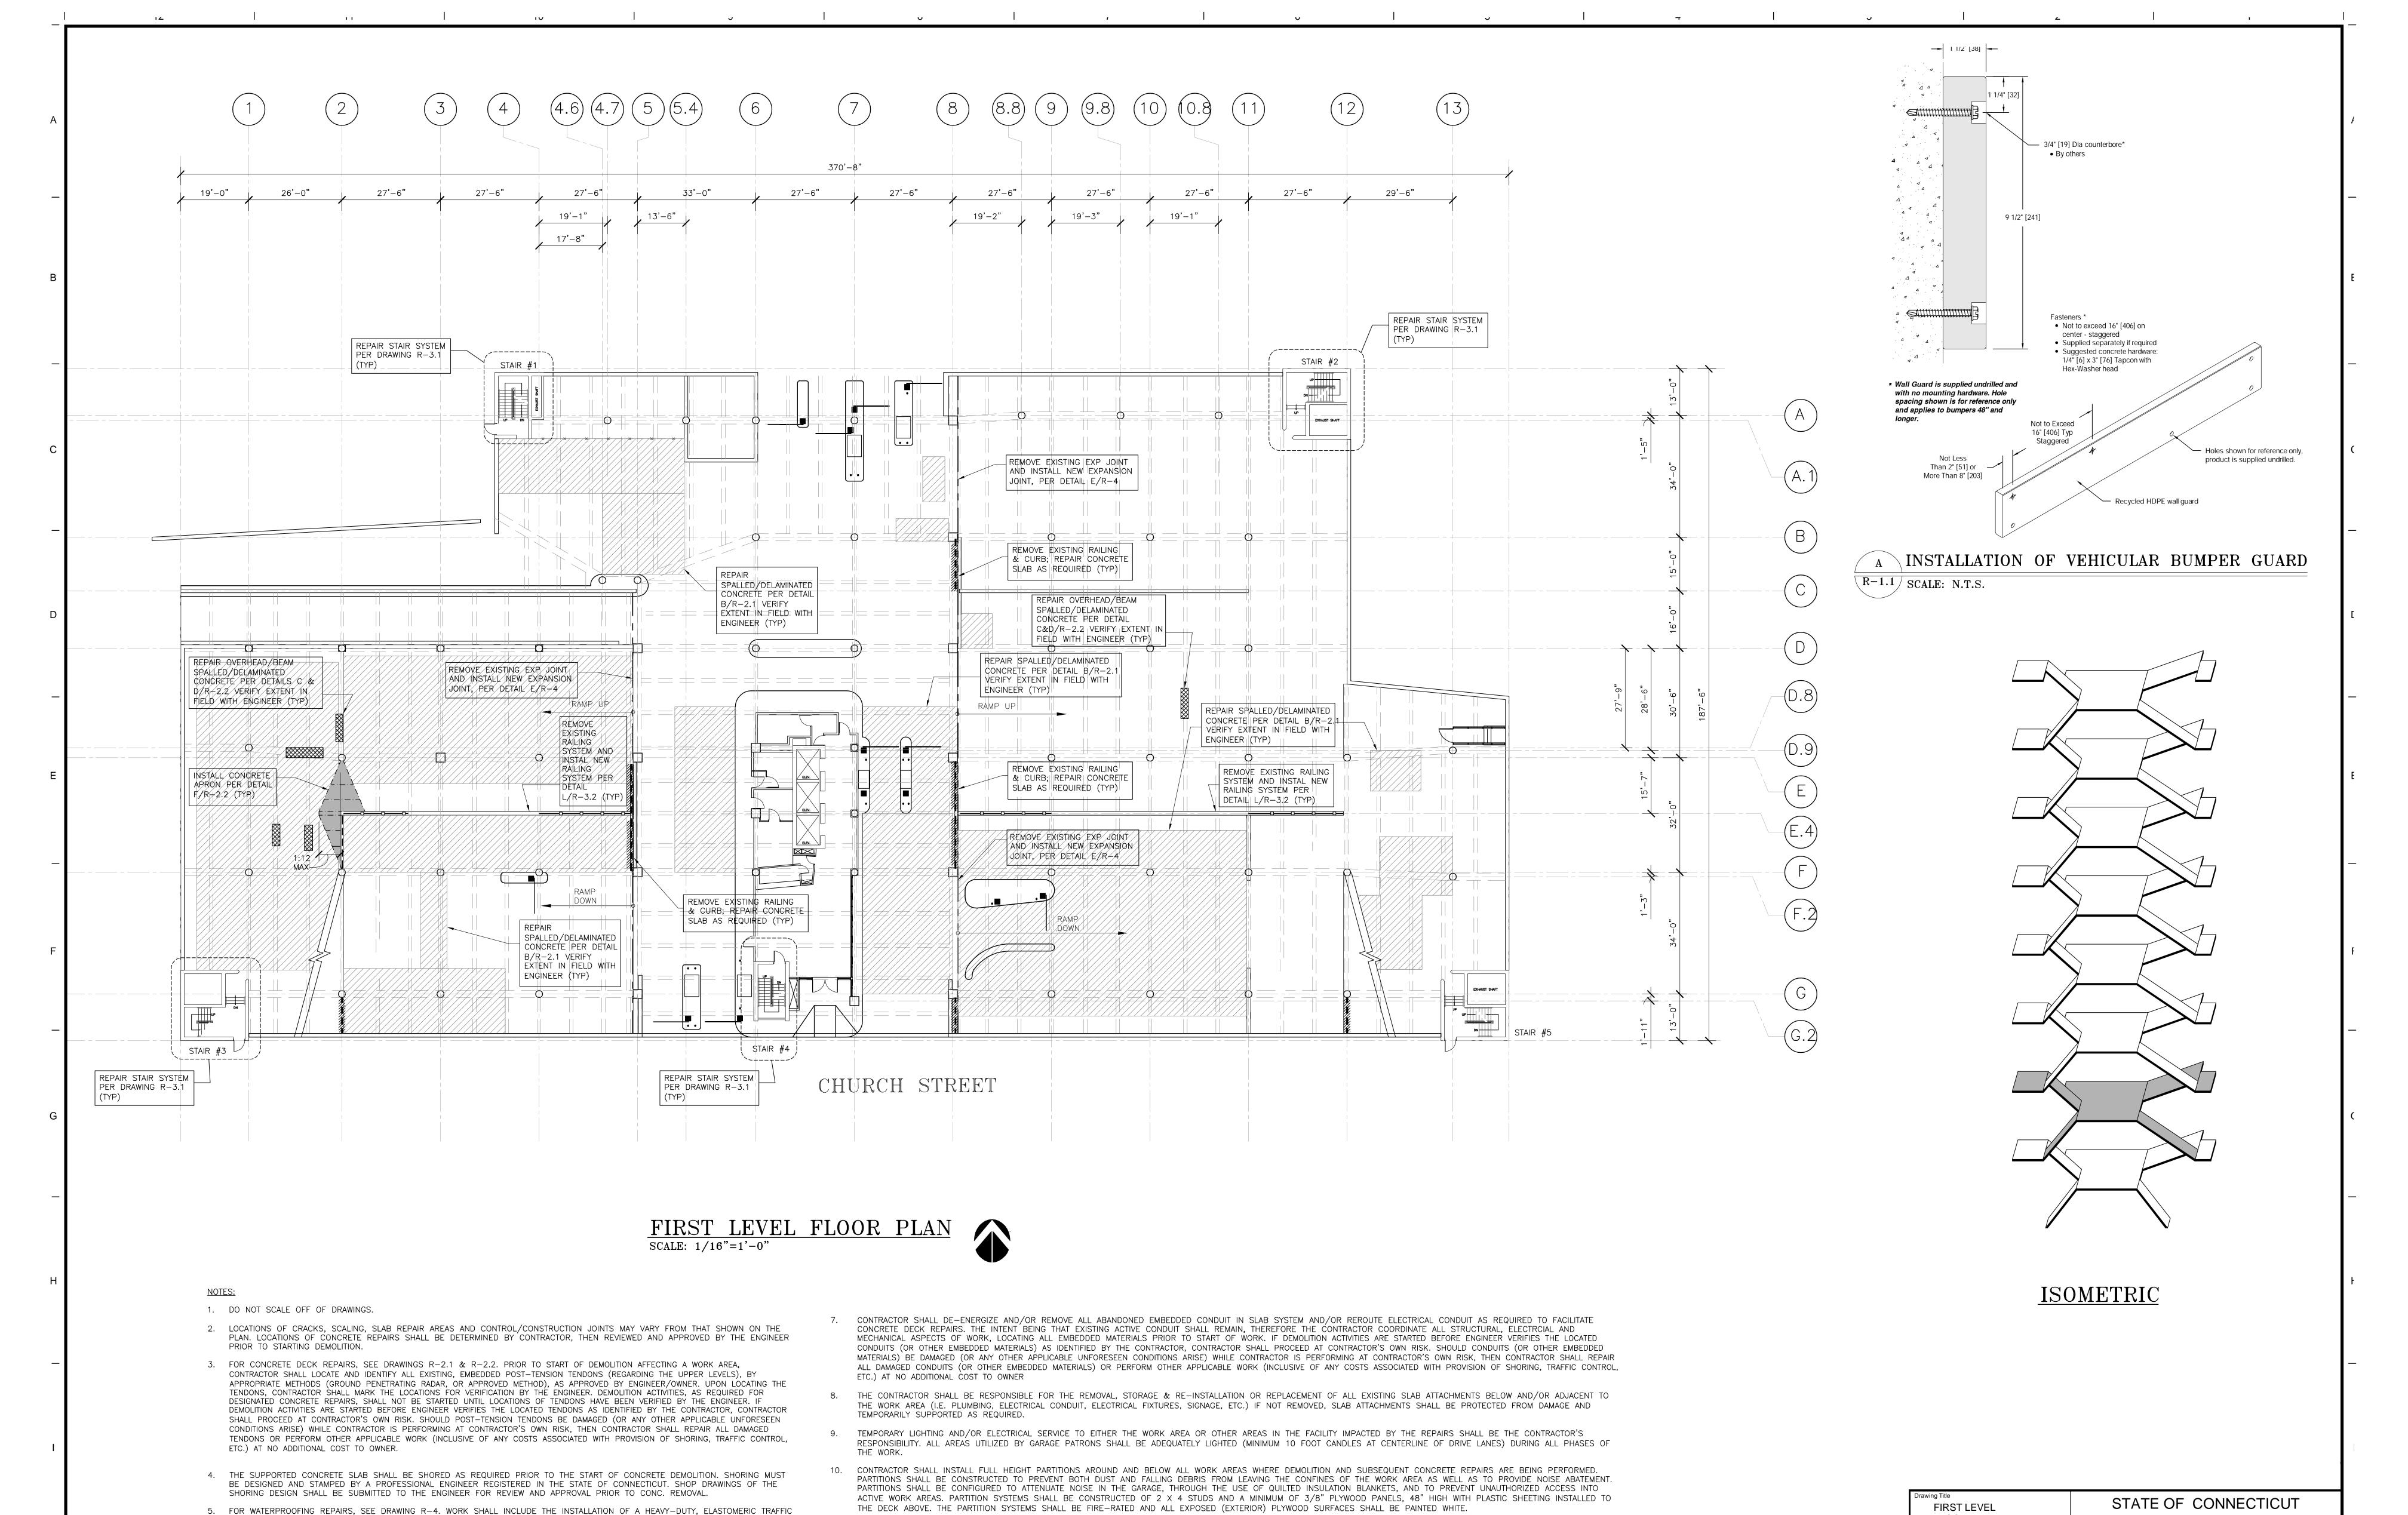

ANCHORS, ETC.) SHALL TYPICALLY BE CONSIDERED ADDRESSABLE BY INSTALLATION OF A LEVELING COURSE IN ACCORDANCE WITH THE OTHERWISE DIRECTED BY THE ENGINEER, HOWEVER ALL HANDICAP PARKING STALLS SHALL BE UPDATED ACCORDINGLY PER CURRENT REQUIREMENTS AND QUANTITY/LOCATION OF MANUFACTURER'S RECOMMENDATIONS; ALL LOCATIONS SHALL BE REVIEWED BY THE MANUFACTURER AND APPROVED BY THE ENGINEER HANDICAP PARKING STALLS SHALL BE VERIFIED PRIOR TO START OF WORK; ALL CURBINGS SHALL BE PAINTED, BOTH THOSE CURRENTLY PAINTED AND THOSE NOT. ANY AND ALL CONFLICTING MARKINGS SHALL BE REMOVED IN THEIR ENTIRETY BY APPROVED METHOD. OWNER/ENGINEER SHALL BE REQUIRED TO REVIEW STRIPING LAYOUT PRIOR TO THIS WORK BEING PERFORMED.

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12

CAPITAL REGION DEVELOPMENT AUTHORITY Description APRIL 2021 AS NOTED oject Manager: CHURCH STREET PARKING GARAGE ect Architect: RENOVATIONS & IMPROVEMENTS eer Reviewer: HARTFORD, CONNECTICUT

21-016

Project Number:

Drawing Number

FLOOR PLAN

AD Number:

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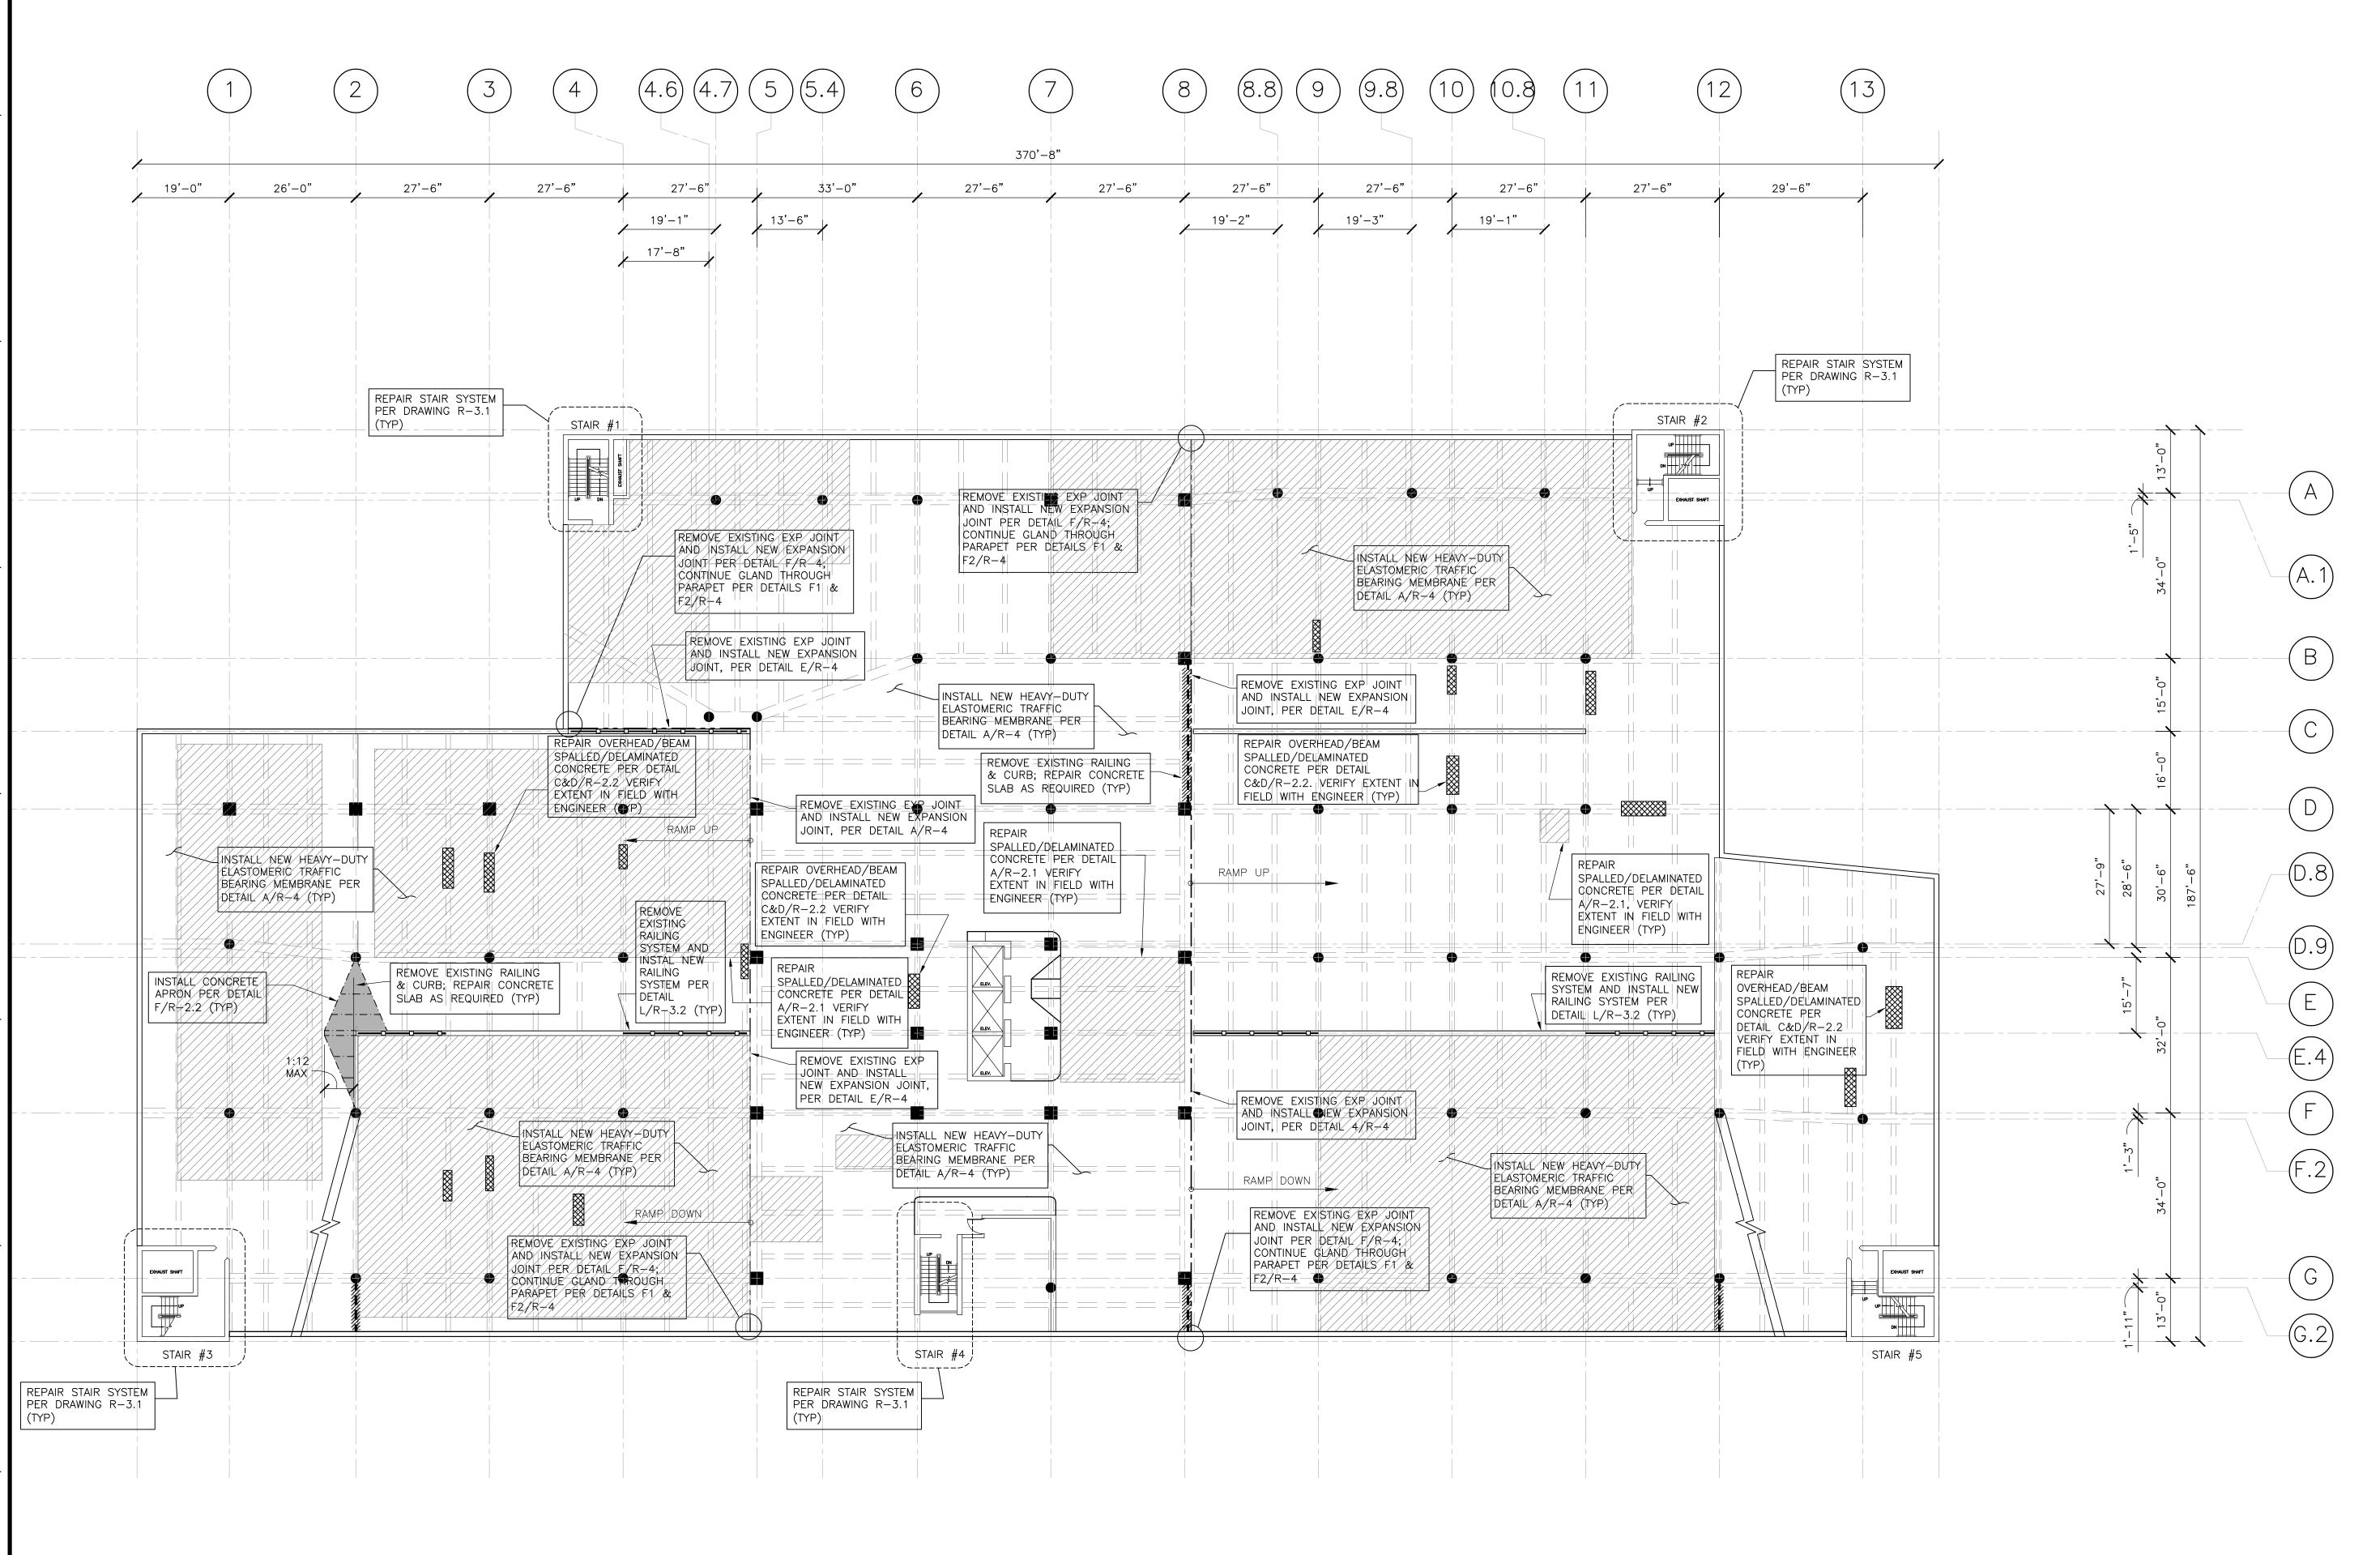
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SECOND LEVEL FLOOR PLAN SCALE: 1/16"=1'-0"

NOTES


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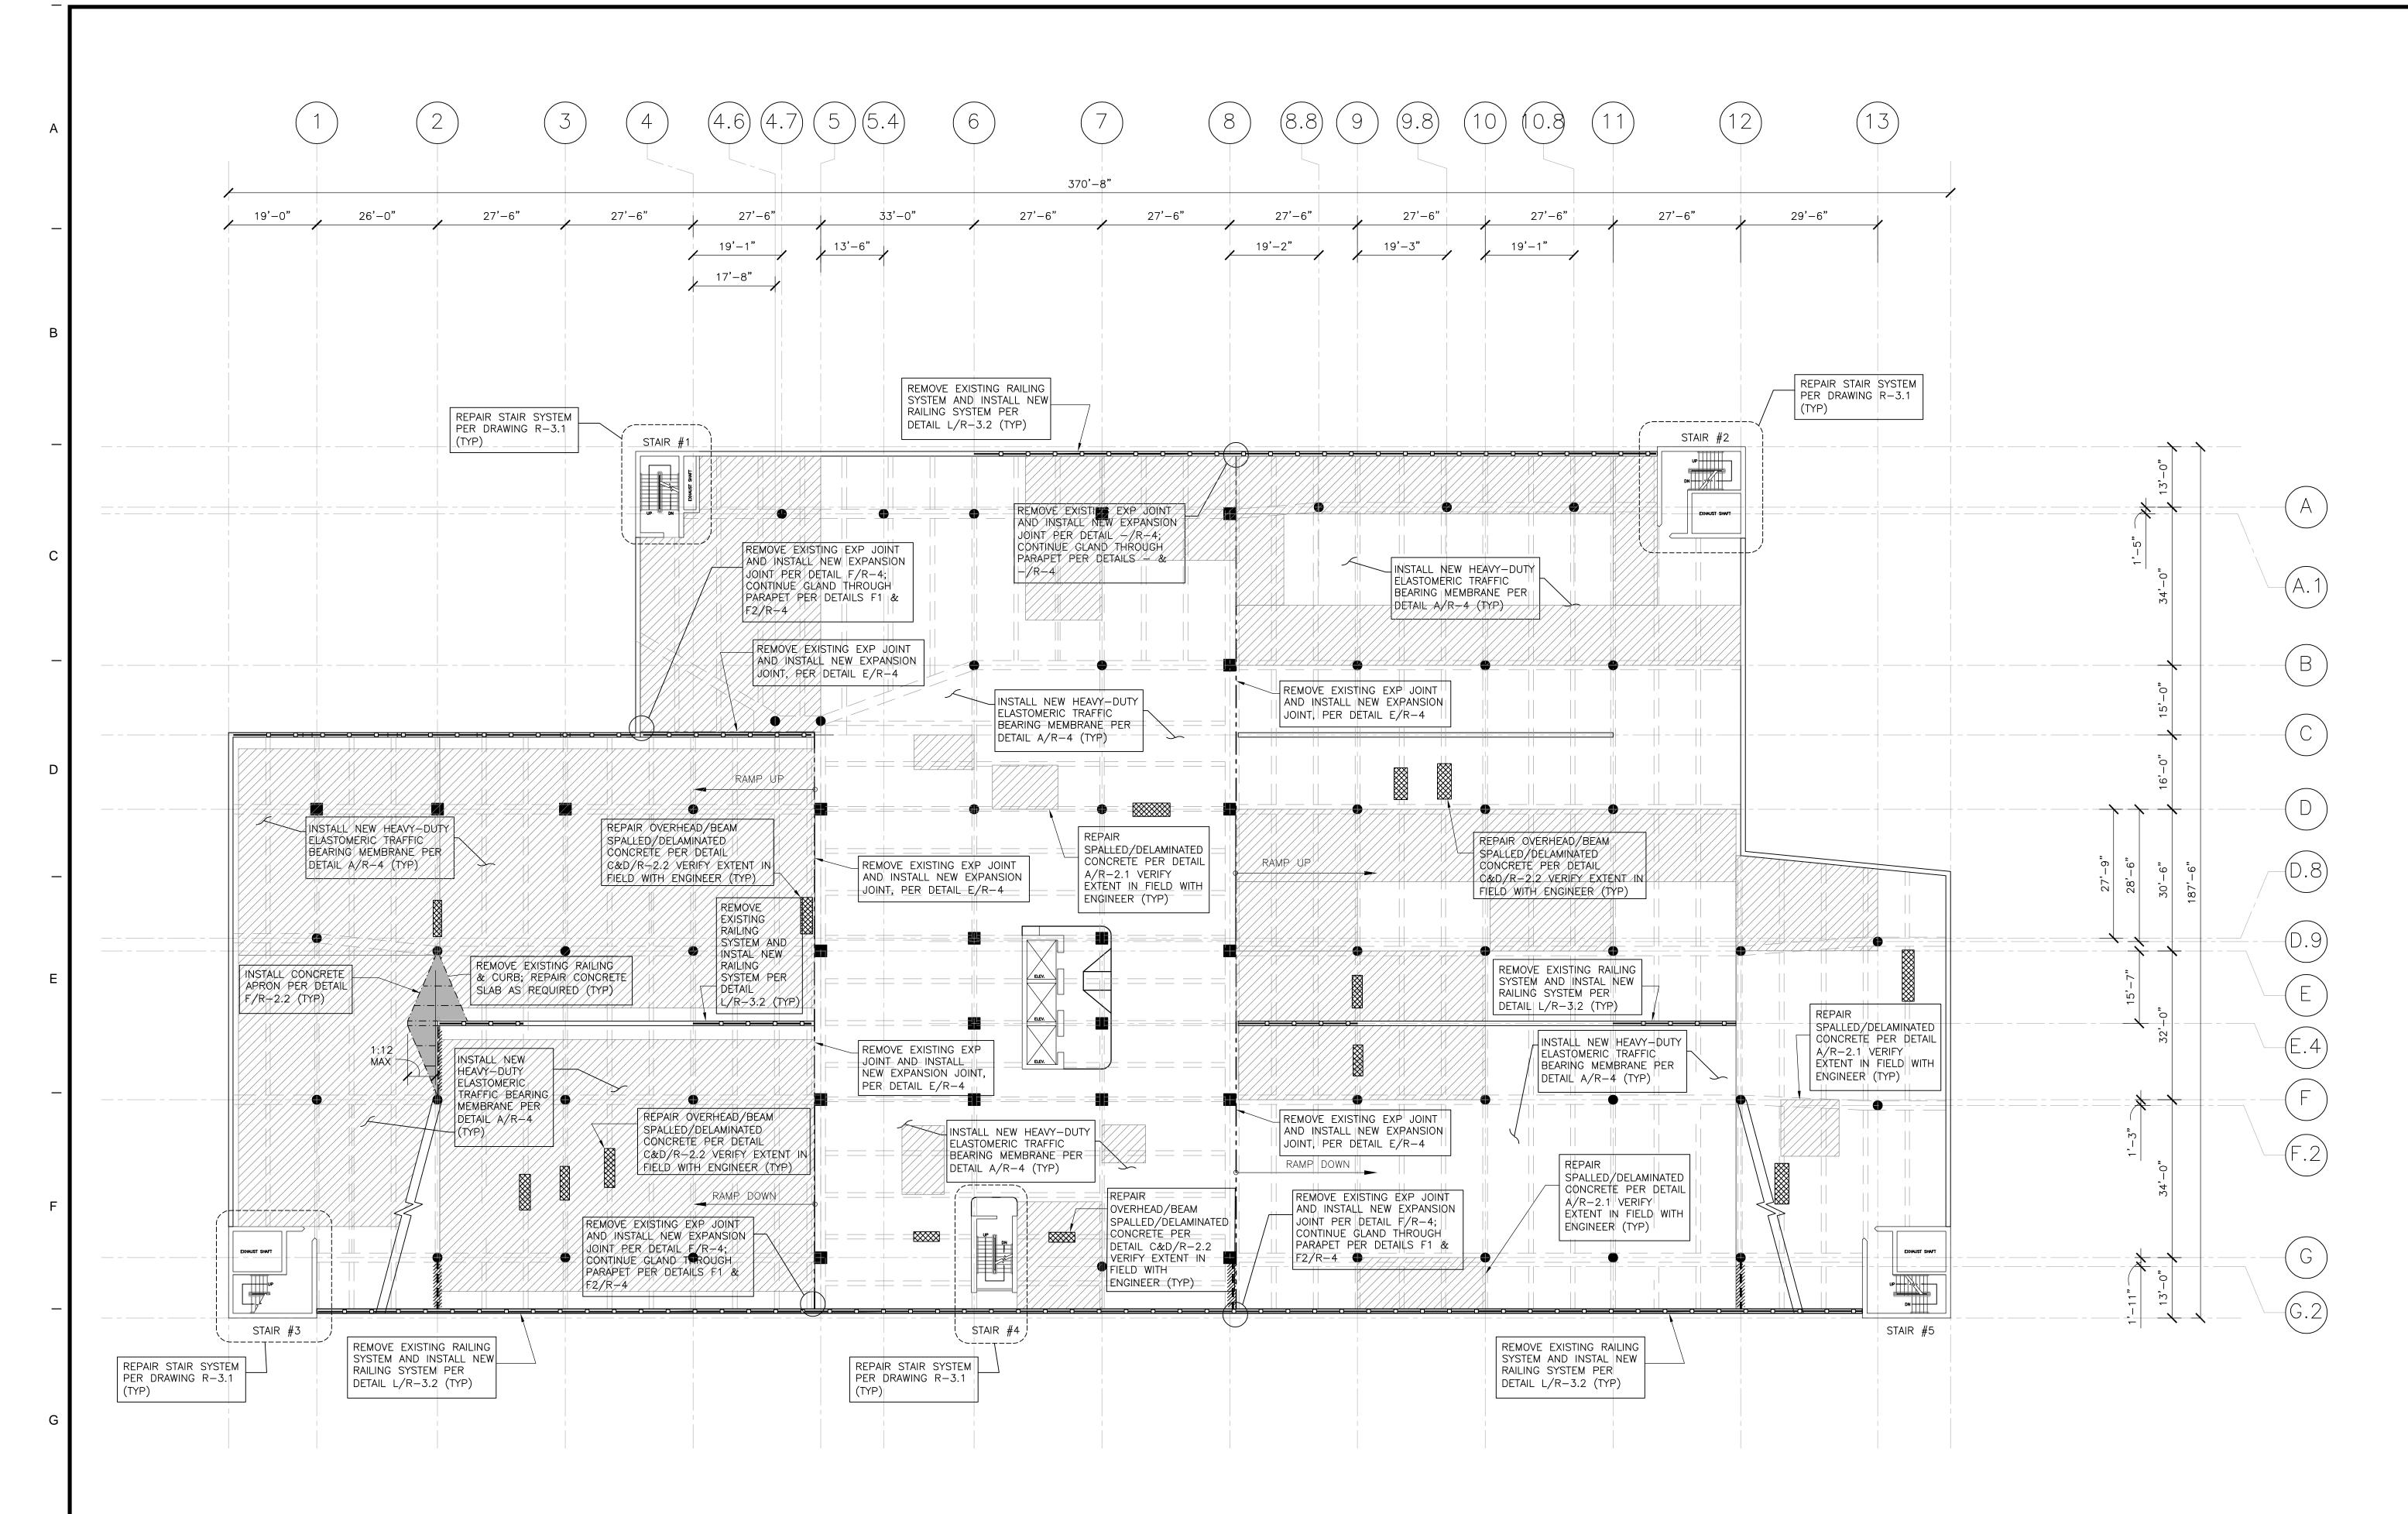
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Drawing Title SECOND LEVEL FLOOR PLAN Revisions			STATE OF CONNECTICUT CAPITAL REGION DEVELOPMENT AUTHORITY	
11011011	.S			D-4
No.	Date	Description	Plans Prepared By:	Date: APRIL 2021
				Scale
				AS NOTED
	Design Management	Design Management	Production Leader	
			Design management	-
			Project:	Project Manager:
			CHURCH STREET PARKING GARAGE	-
			RENOVATIONS & IMPROVEMENTS	Project Architect:
				Peer Reviewer:
			HARTFORD, CONNECTICUT	-
				Drawing Number
CAD Numbe	er:		Project Number:	R-1.2
			21-016	






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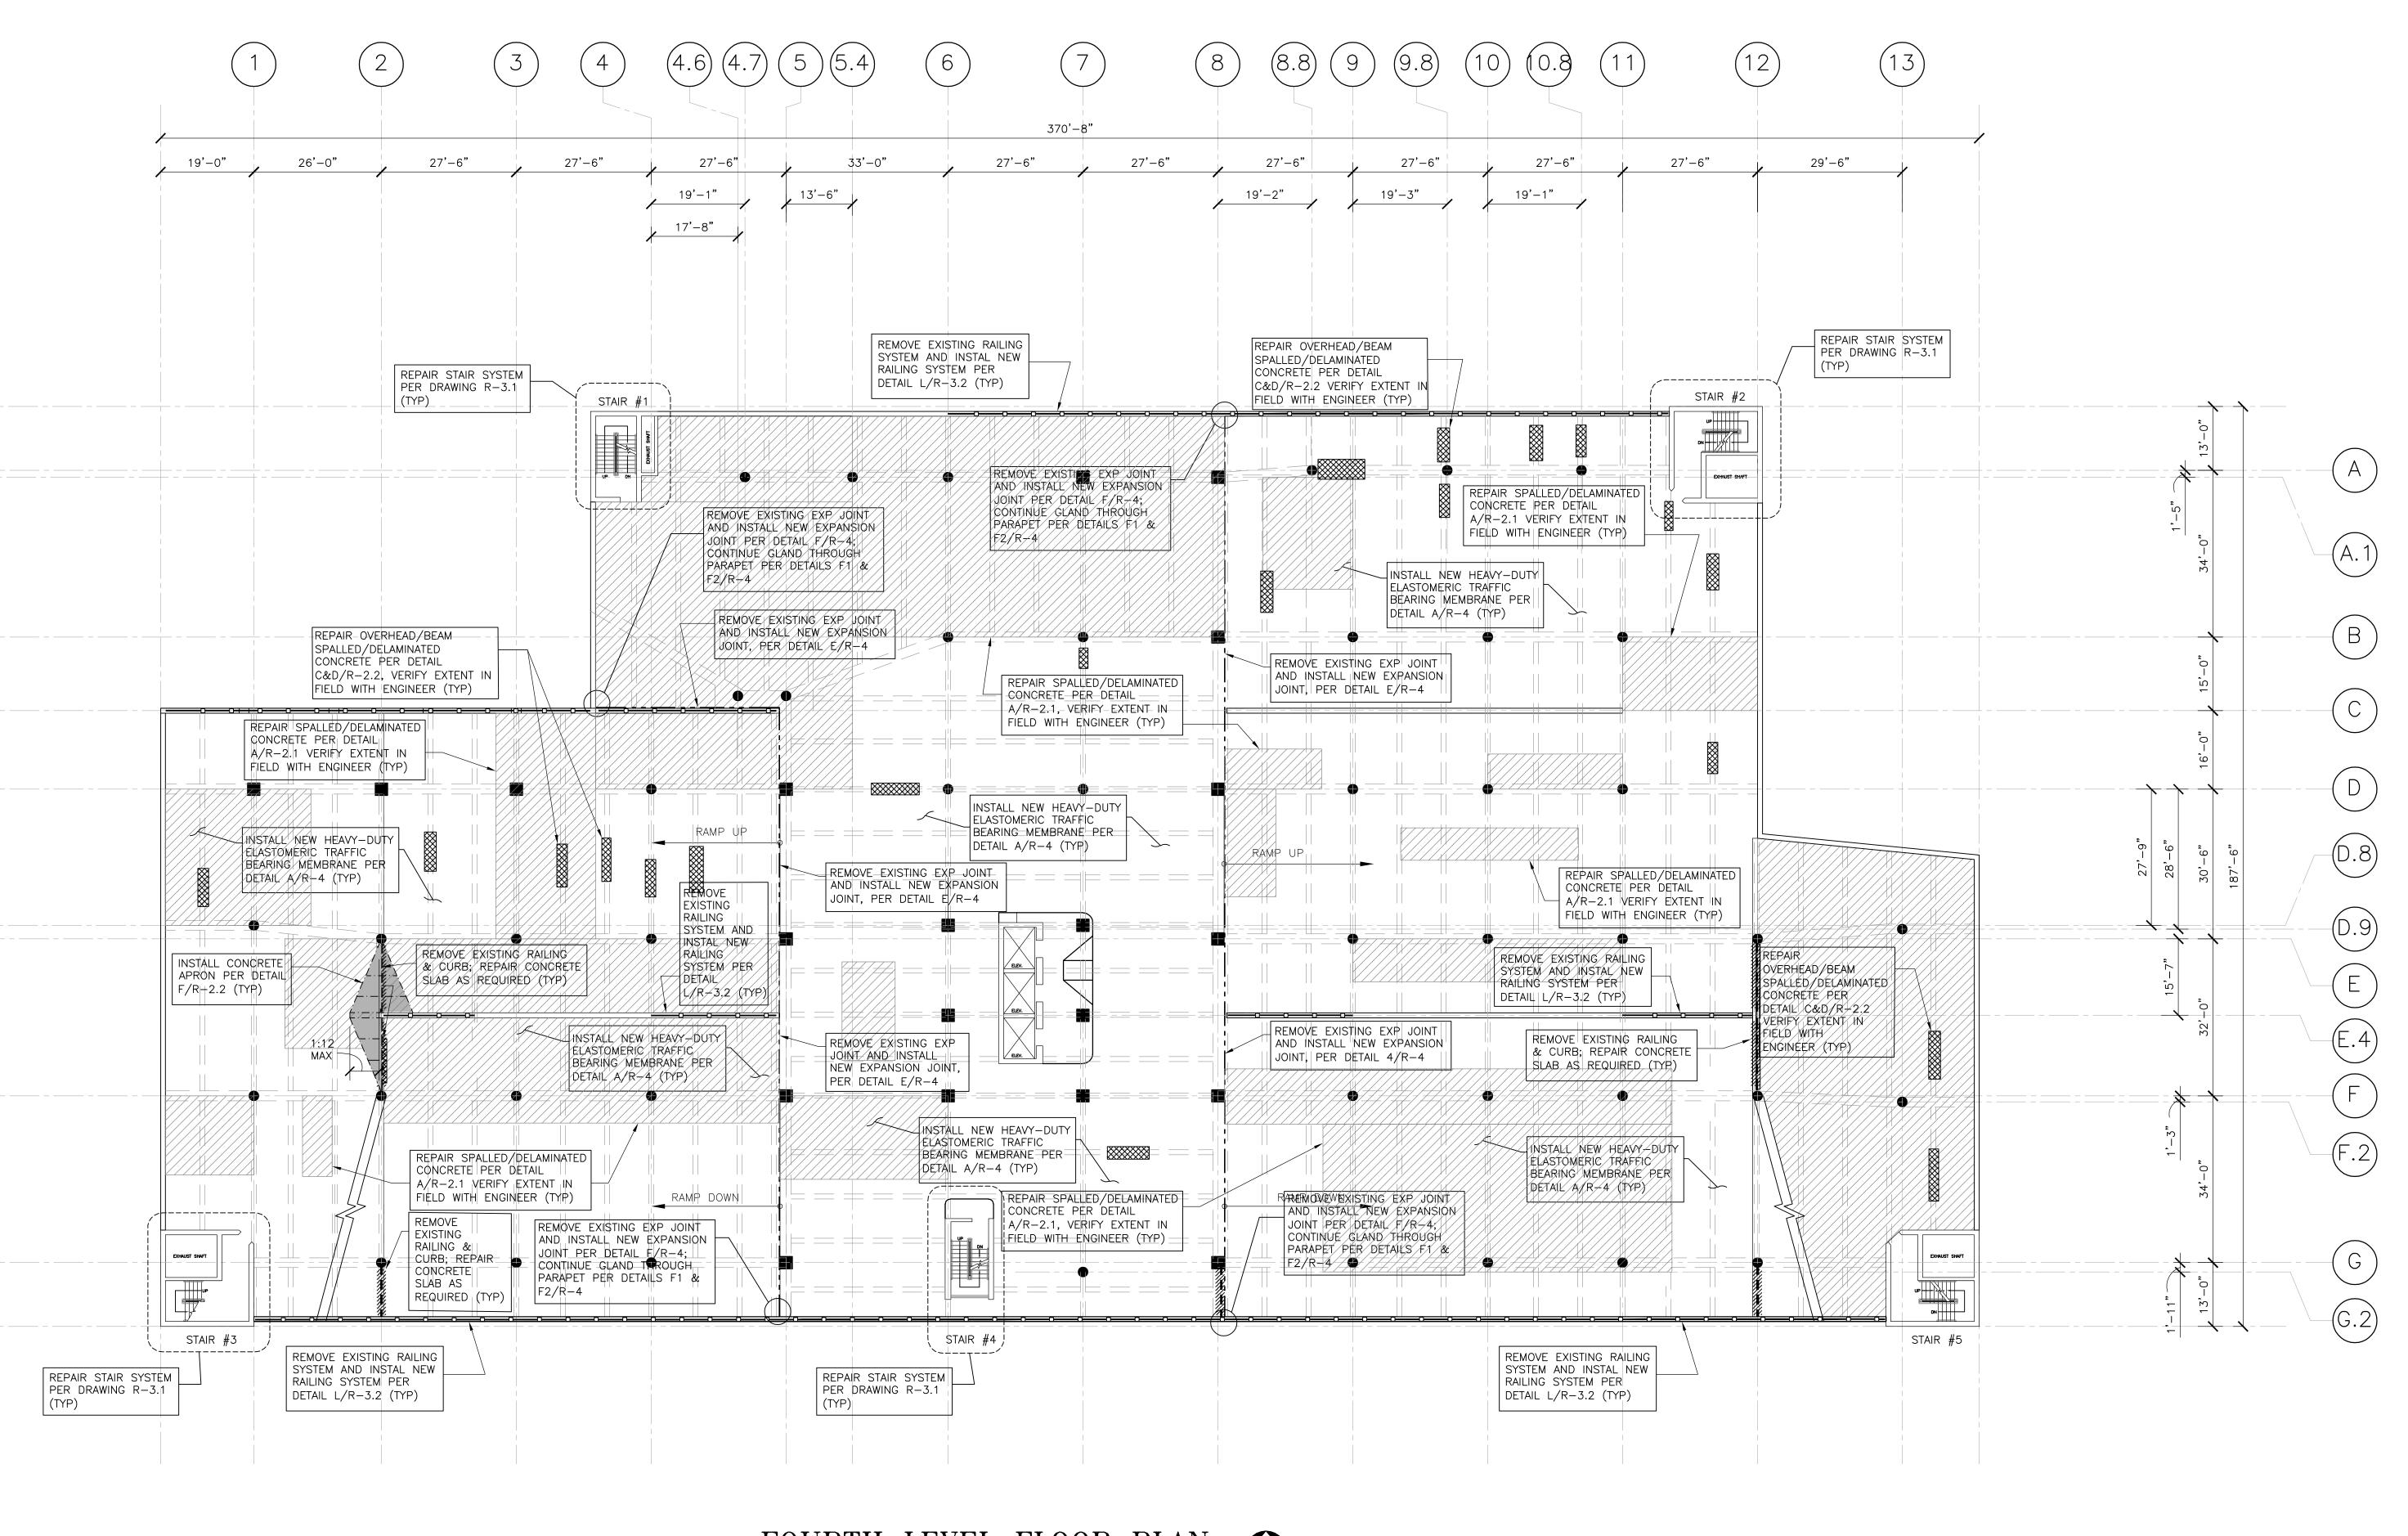
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- 3. FOR CONCRETE DECK REPAIRS, SEE DRAWINGS R-2.1 & R-2.2. PRIOR TO START OF DEMOLITION AFFECTING A WORK AREA, CONTRACTOR SHALL LOCATE AND IDENTIFY ALL EXISTING, EMBEDDED POST-TENSION TENDONS (REGARDING THE UPPER LEVELS), BY APPROPRIATE METHODS (GROUND PENETRATING RADAR, OR APPROVED METHOD), AS APPROVED BY ENGINEER/OWNER. UPON LOCATING THE TENDONS, CONTRACTOR SHALL MARK THE LOCATIONS FOR VERIFICATION BY THE ENGINEER. DEMOLITION ACTIVITIES, AS REQUIRED FOR DESIGNATED CONCRETE REPAIRS, SHALL NOT BE STARTED UNTIL LOCATIONS OF TENDONS HAVE BEEN VERIFIED BY THE ENGINEER. IF DEMOLITION ACTIVITIES ARE STARTED BEFORE ENGINEER VERIFIES THE LOCATED TENDONS AS IDENTIFIED BY THE CONTRACTOR, CONTRACTOR SHALL PROCEED AT CONTRACTOR'S OWN RISK. SHOULD POST-TENSION TENDONS BE DAMAGED (OR ANY OTHER APPLICABLE UNFORESEEN CONDITIONS ARISE) WHILE CONTRACTOR IS PERFORMING AT CONTRACTOR'S OWN RISK, THEN CONTRACTOR SHALL REPAIR ALL DAMAGED TENDONS OR PERFORM OTHER APPLICABLE WORK (INCLUSIVE OF ANY COSTS ASSOCIATED WITH PROVISION OF SHORING, TRAFFIC CONTROL, ETC.) AT NO ADDITIONAL COST TO OWNER.
- 4. THE SUPPORTED CONCRETE SLAB SHALL BE SHORED AS REQUIRED PRIOR TO THE START OF CONCRETE DEMOLITION. SHORING MUST BE DESIGNED AND STAMPED BY A PROFESSIONAL ENGINEER REGISTERED IN THE STATE OF CONNECTICUT. SHOP DRAWINGS OF THE SHORING DESIGN SHALL BE SUBMITTED TO THE ENGINEER FOR REVIEW AND APPROVAL PRIOR TO CONC. REMOVAL.
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- 11. THE CONTRACTOR SHALL PROVIDE MAXIMUM VEHICULAR AND PEDESTRIAN MOBILITY THROUGH AND/OR IN THE VICINITY OF THE PROJECT AREA. PROPER COORDINATION BETWEEN THE CONTRACTOR AND GARAGE MANAGEMENT STAFF SHALL BE REQUIRED IN THE SEQUENCING AND SCHEDULING OF REPAIRS. MOVEMENT OF MATERIAL, CONSTRUCTION DEBRIS AND THE REMOBILIZATION OF NEW WORK AREAS SHALL NOT TAKE PLACE DURING PERIODS OF PEAK TRAFFIC FLOW. BOTH VEHICULAR AND PEDESTRIAN TRAFFIC SHALL BE MAINTAINED AT ALL TIMES, AND CONTRACTOR SHALL INSTALL TRAFFIC CONTROL SIGNS AND LIGHTS FOR THE SAFE PASSAGE THROUGH THE GARAGE, THROUGH THE STAIRS, AND AT THE ENTRANCES AND EXITS DURING THE ENTIRE CONSTRUCTION PERIOD. ONLY ONE STAIR AND/OR ONE ELEVATOR MAY BE TAKEN OUT OF SERVICE AT ANY GIVEN TIME BUT NEVER BOTH AT THE SAME STAIR/ELEVATOR TOWER, PROPERLY COORDINATED WITH OWNER IN ADVANCE. SIGNAGE MAY BE REQUIRED ON THE SURROUNDING STREETS IF REPAIR WORK IS TO BE ACCOMPLISHED ON THE ENTRY/EXIT RAMPS. CONTRACTOR IS TO OBTAIN PERMITS FROM APPROPRIATE AGENCIES.
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Drawing Title THIRD LEVEL FLOOR PLAN Revisions			STATE OF CONNECTICUT CAPITAL REGION DEVELOPMENT AUTHORITY	
No.	Date	Description	Plans Prepared By:	Date: APRIL 2021
			DESMAN	Scale AS NOTED
			Design Management	Production Leader -
			Project:	Project Manager:
			CHURCH STREET PARKING GARAGE	-
			RENOVATIONS & IMPROVEMENTS	Project Architect:
			HARTFORD, CONNECTICUT	Peer Reviewer:
				Drawing Number
CAD Numb	per:		Project Number: 21-016	R-1.3

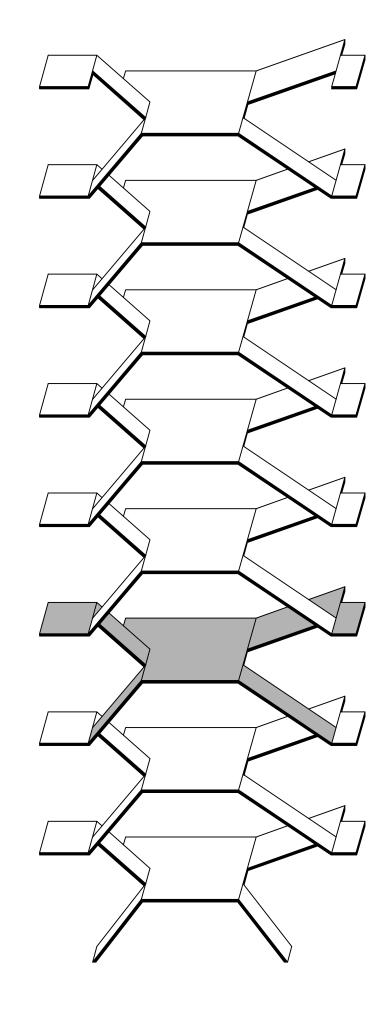

FOURTH LEVEL FLOOR PLAN
SCALE: 1/16"=1'-0"


BEING PERFORMED.
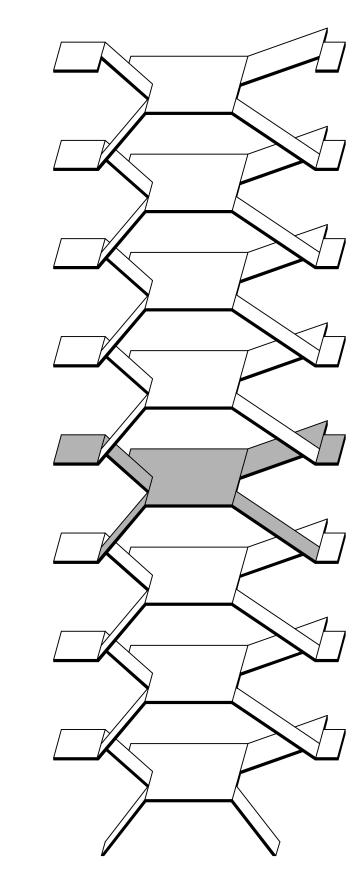
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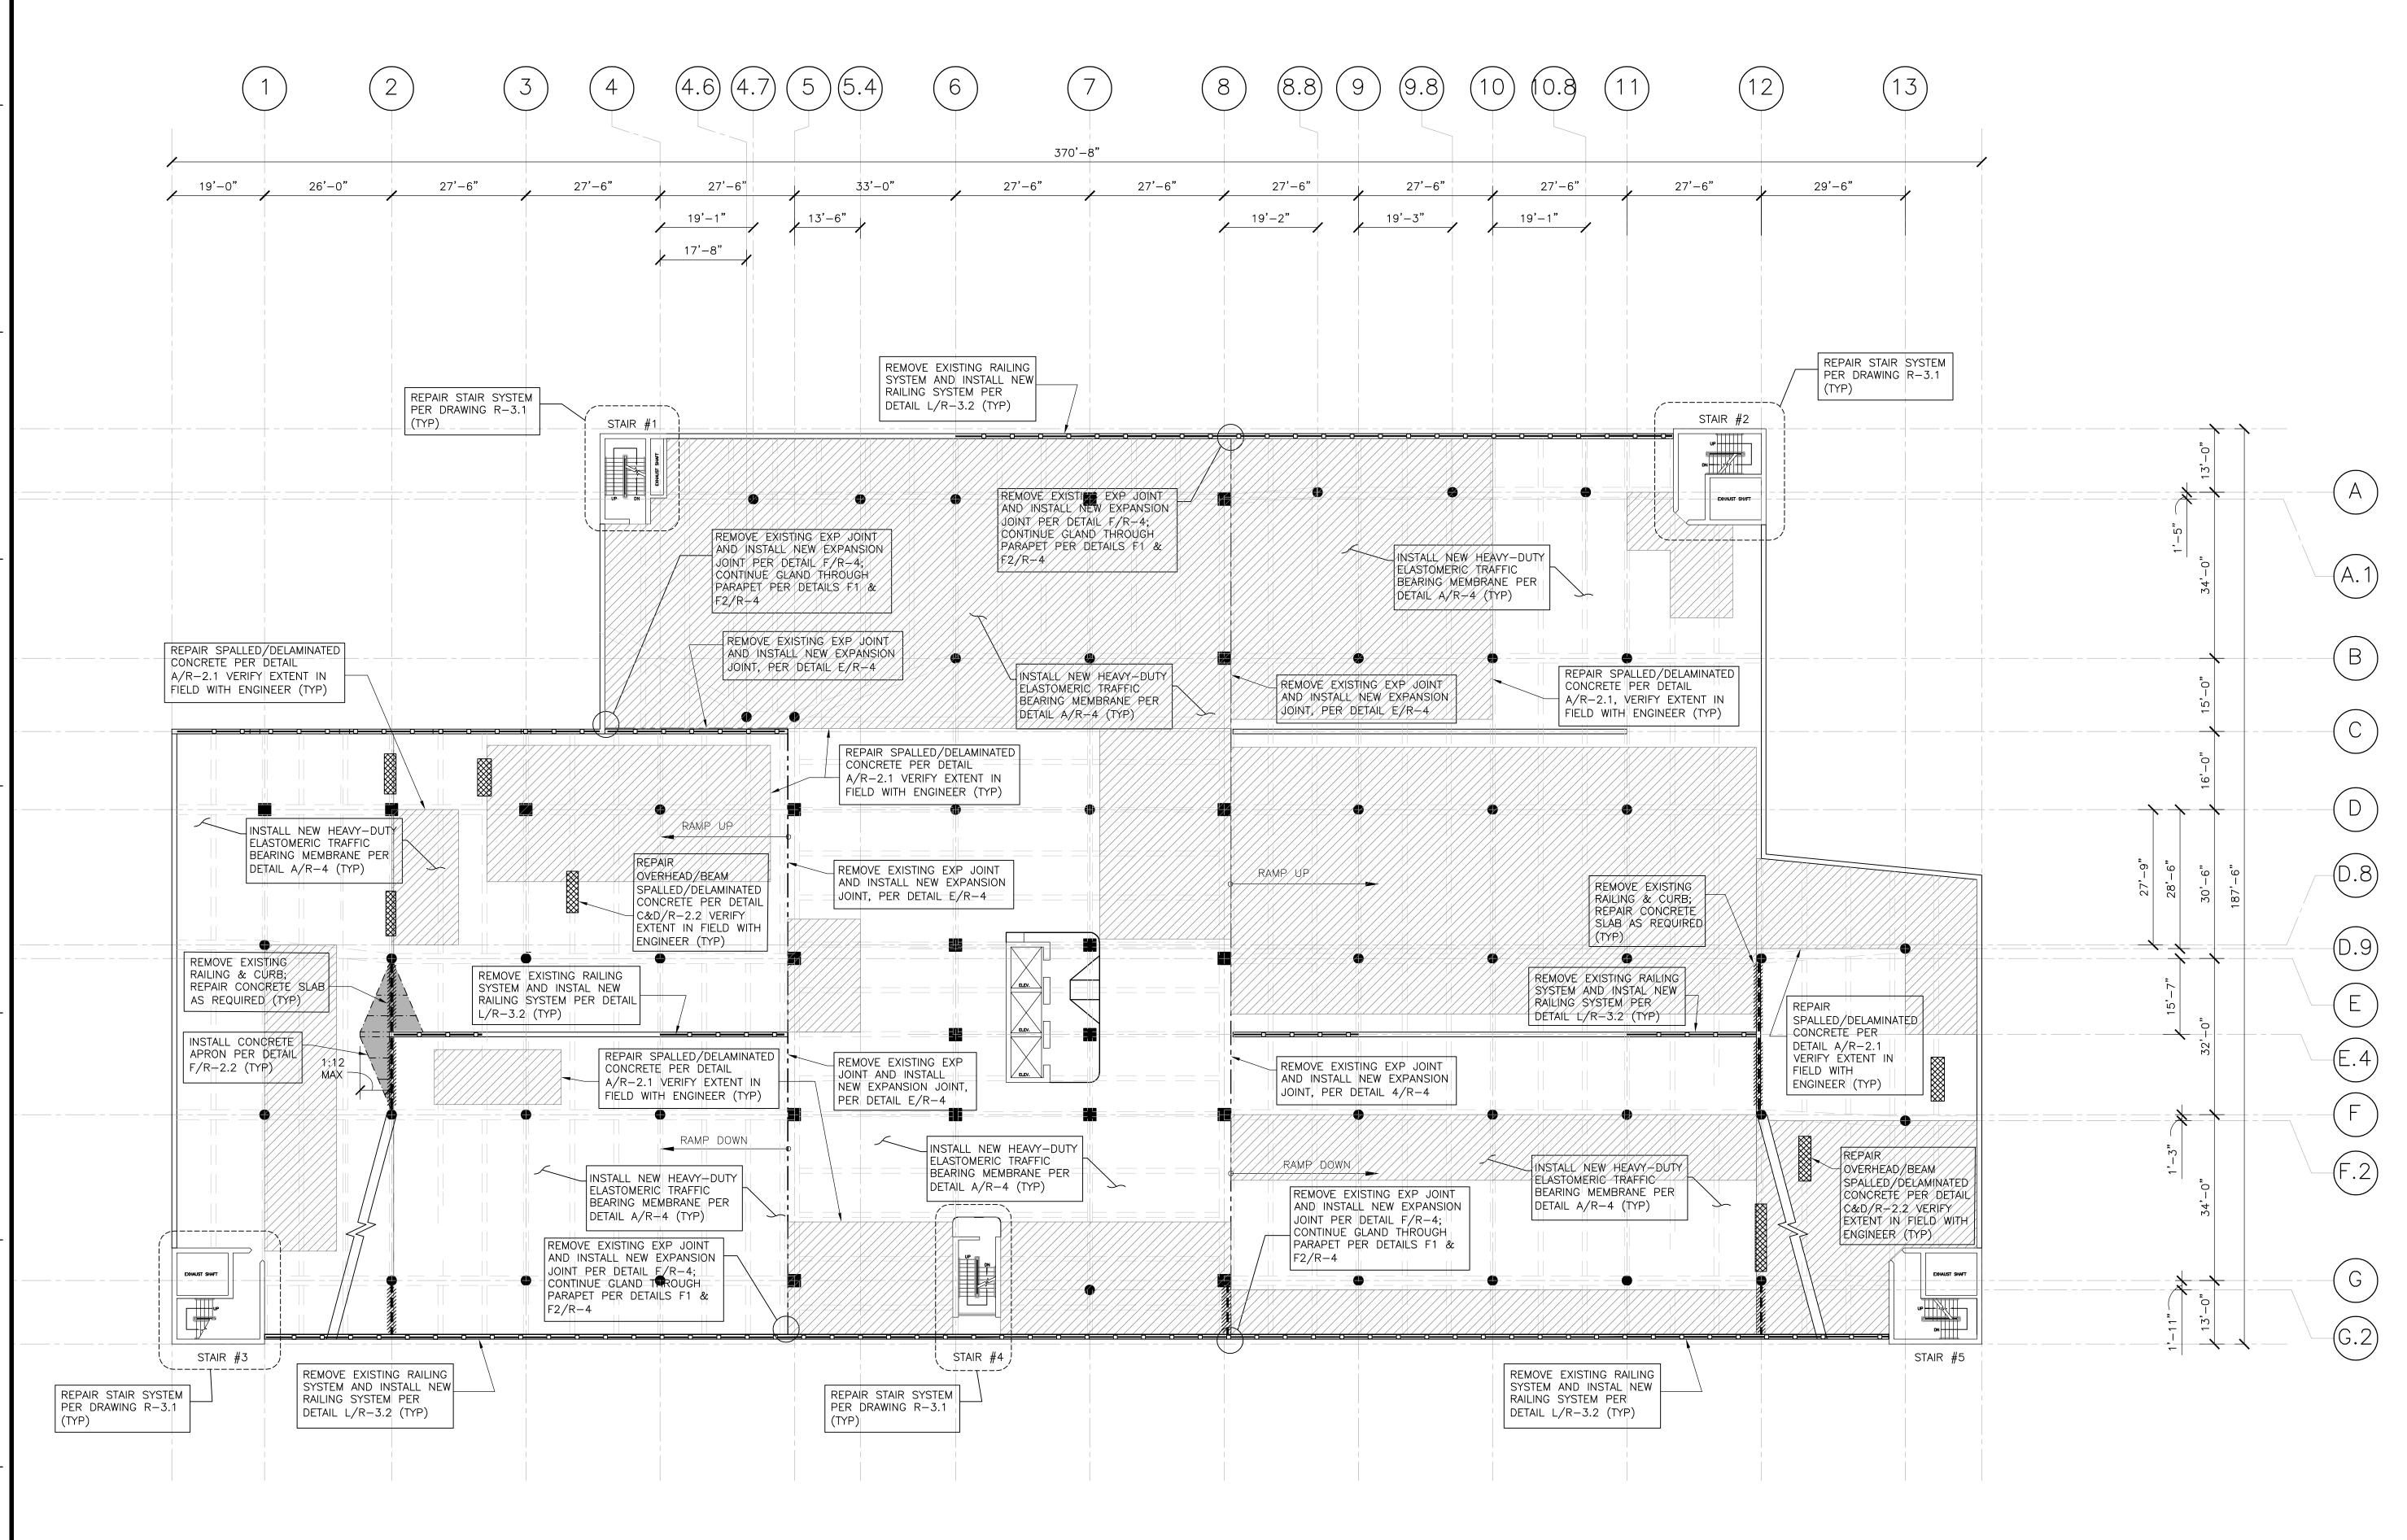
12

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FOURTH LEVEL FLOOR PLAN			STATE OF CONNECTICUT CAPITAL REGION DEVELOPMENT AUTHORITY		
No.	Date	Description	Project: CHURCH STREET PARKING GARAGE RENOVATIONS & IMPROVEMENTS HARTFORD, CONNECTICUT	Date: APRIL 2021 Scale AS NOTED Production Leader - Project Manager: - Project Architect: - Peer Reviewer: - Drawing Number	
D Number:			Project Number: 21-016	R-1.4	



FIFTH LEVEL FLOOR PLAN
SCALE: 1/16"=1'-0"

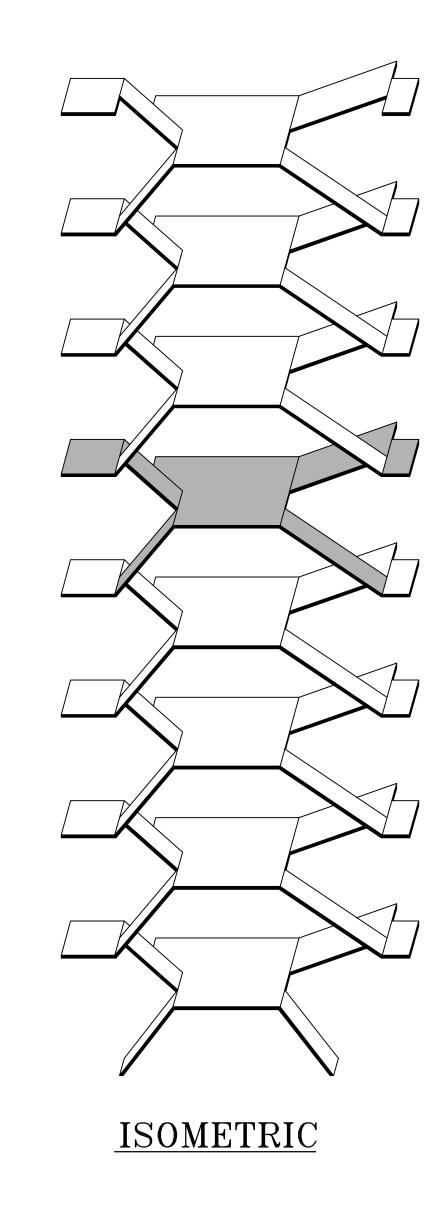


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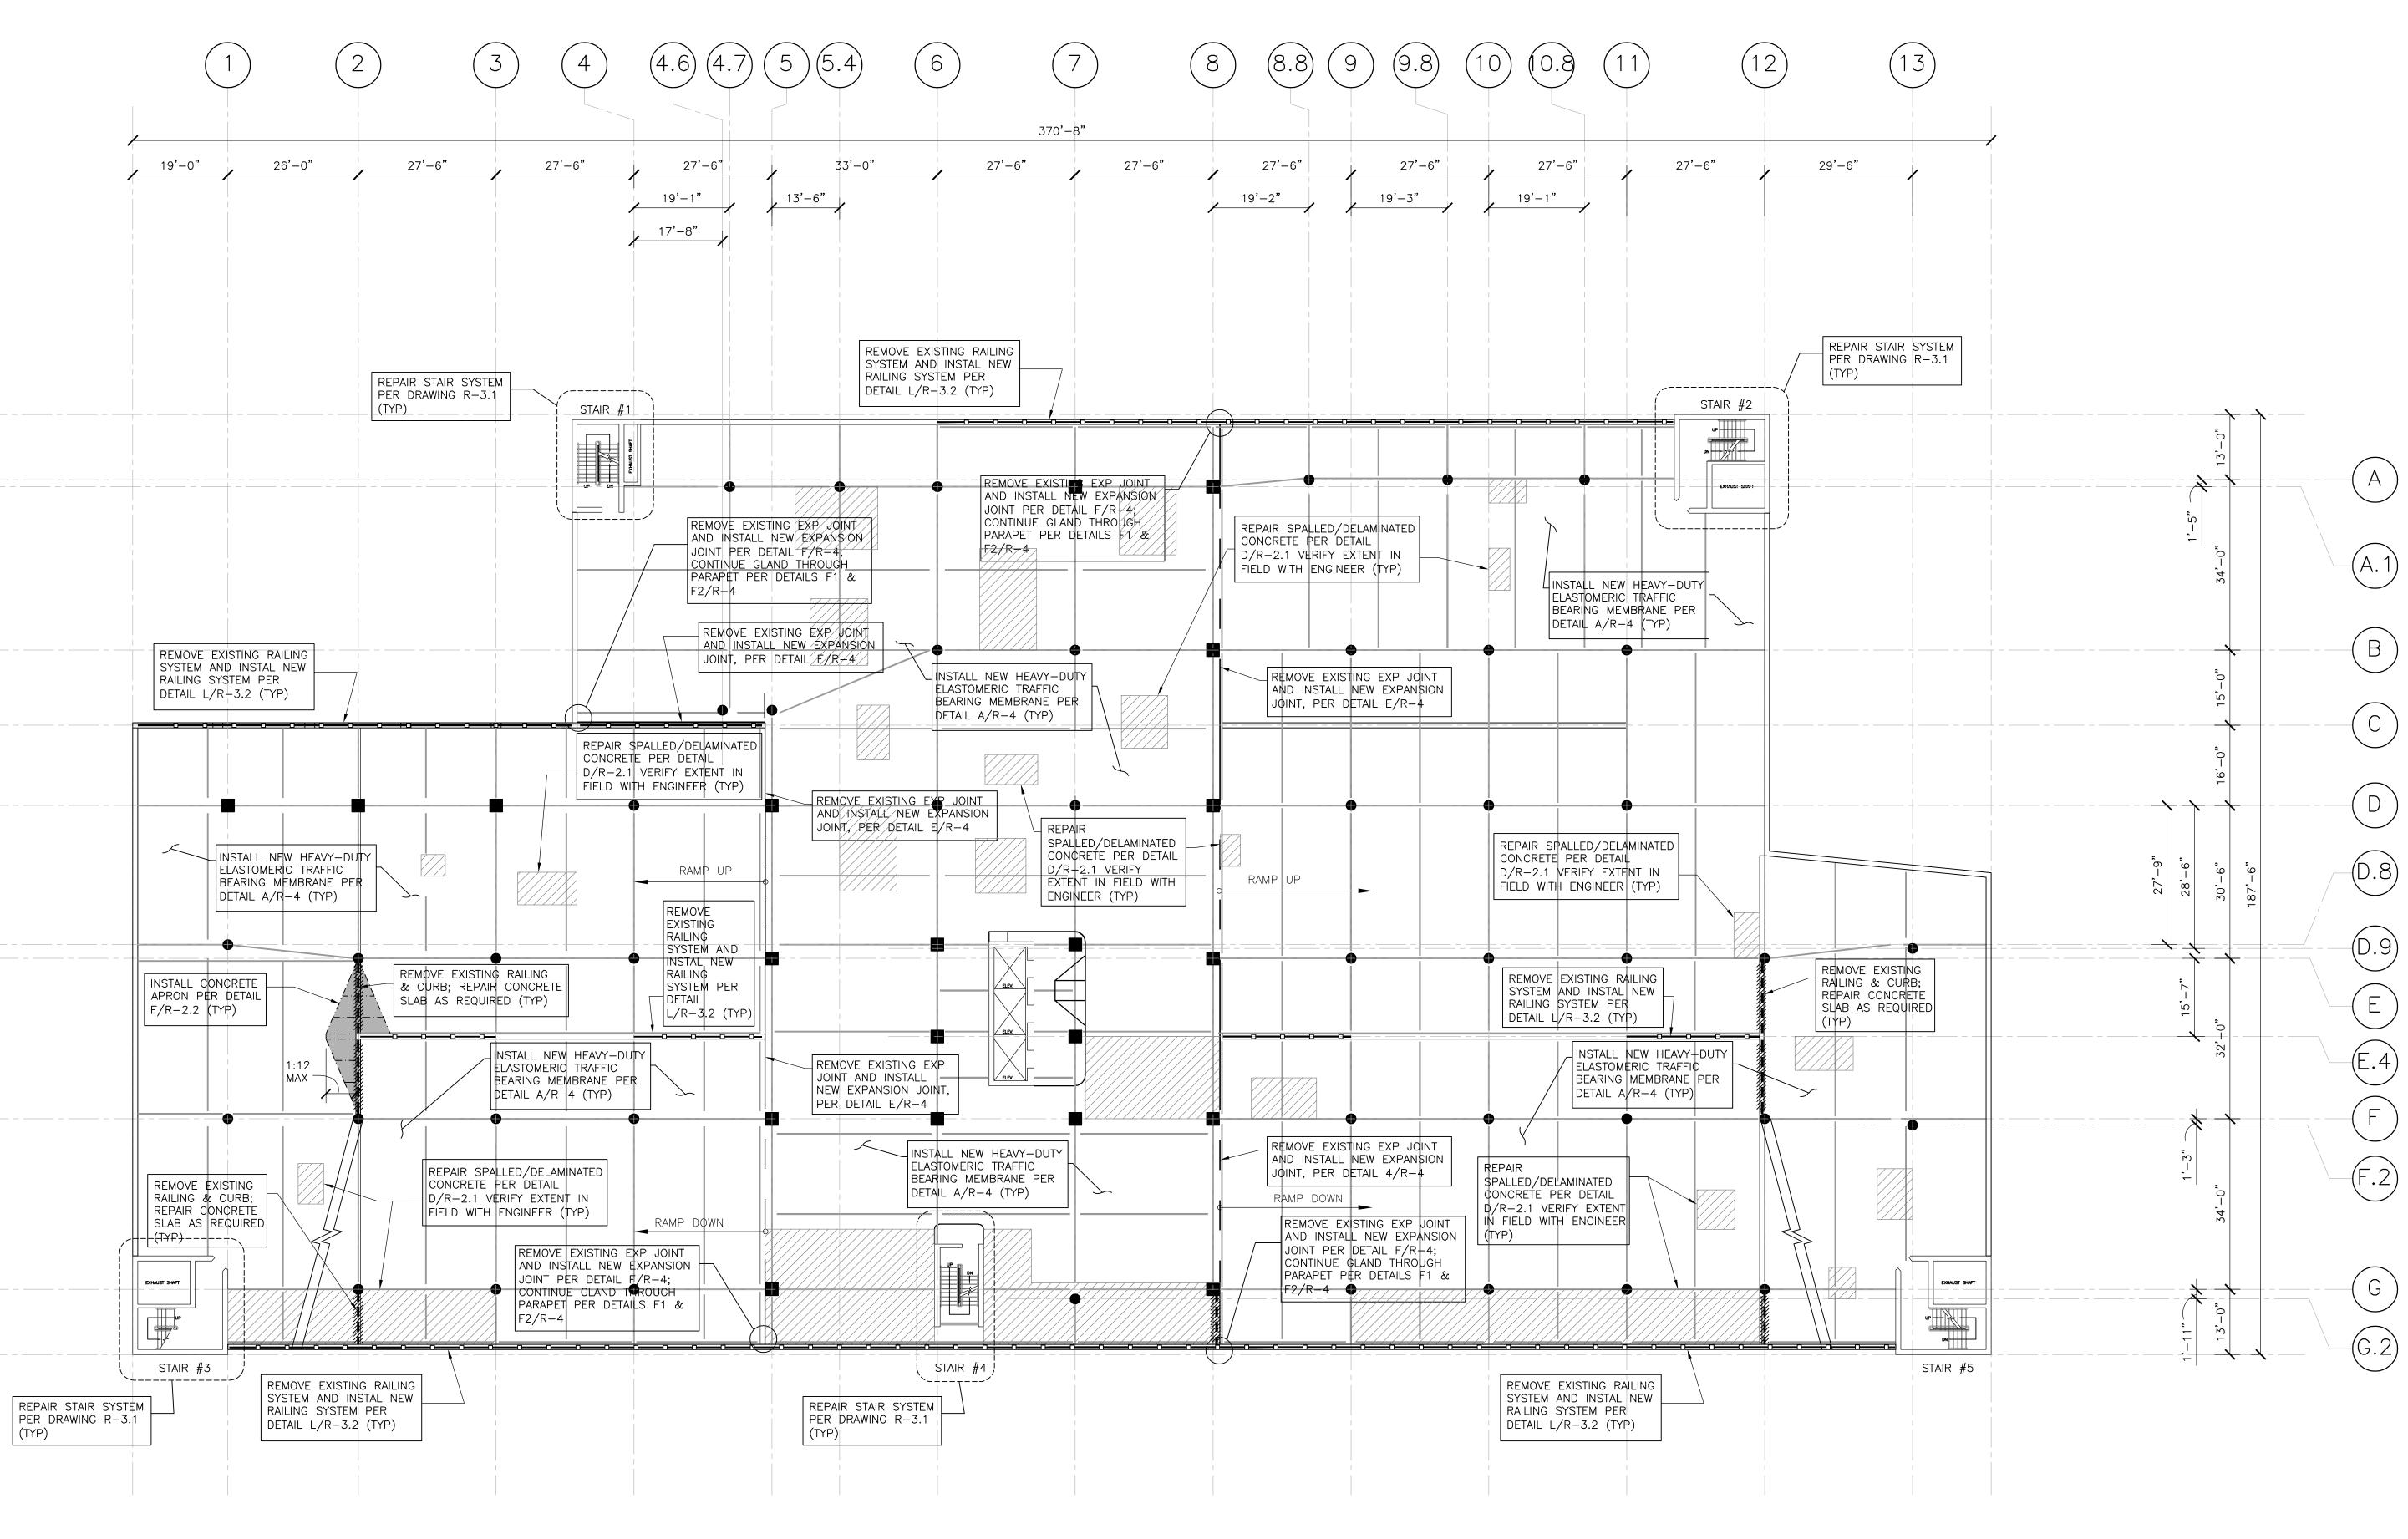
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No.	Date	Description	Plans Prepared By:	Date: APRIL 2021	
				Scale	
			I II IAS IVI A IN	AS NOTED	
			Design Management	Production Leader	
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			Project:	Project Manager:	
			CHURCH STREET PARKING GARAGE	-	
			RENOVATIONS & IMPROVEMENTS	Project Architect:	
				Peer Reviewer:	
			HARTFORD, CONNECTICUT	-	
				Drawing Number	
CAD Numb	er:		Project Number: 21-016	R-1.5	



ISOMETRIC

SIXTH LEVEL FLOOR PLAN SCALE: 1/16"=1'-0"

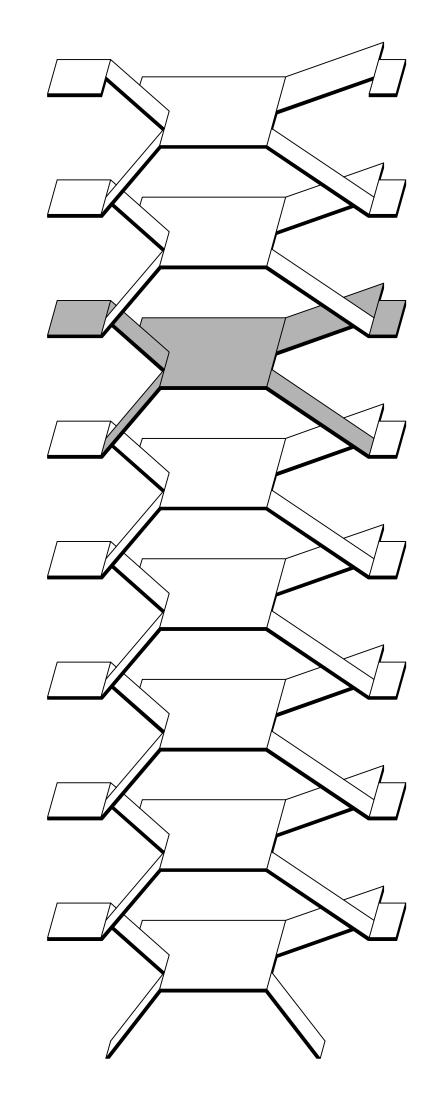
NOTES:

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- 1. DO NOT SCALE OFF OF DRAWINGS.
- 2. LOCATIONS OF CRACKS, SCALING, SLAB REPAIR AREAS AND CONTROL/CONSTRUCTION JOINTS MAY VARY FROM THAT SHOWN ON THE PLAN. LOCATIONS OF CONCRETE REPAIRS SHALL BE DETERMINED BY CONTRACTOR, THEN REVIEWED AND APPROVED BY THE ENGINEER PRIOR TO STARTING DEMOLITION.
- 3. FOR CONCRETE DECK REPAIRS, SEE DRAWINGS R-2.1 & R-2.2. PRIOR TO START OF DEMOLITION AFFECTING A WORK AREA, CONTRACTOR SHALL LOCATE AND IDENTIFY ALL EXISTING, EMBEDDED POST-TENSION TENDONS (REGARDING THE UPPER LEVELS), BY APPROPRIATE METHODS (GROUND PENETRATING RADAR, OR APPROVED METHOD), AS APPROVED BY ENGINEER/OWNER. UPON LOCATING THE TENDONS, CONTRACTOR SHALL MARK THE LOCATIONS FOR VERIFICATION BY THE ENGINEER. DEMOLITION ACTIVITIES, AS REQUIRED FOR DESIGNATED CONCRETE REPAIRS, SHALL NOT BE STARTED UNTIL LOCATIONS OF TENDONS HAVE BEEN VERIFIED BY THE ENGINEER. IF DEMOLITION ACTIVITIES ARE STARTED BEFORE ENGINEER VERIFIES THE LOCATED TENDONS AS IDENTIFIED BY THE CONTRACTOR, CONTRACTOR SHALL PROCEED AT CONTRACTOR'S OWN RISK. SHOULD POST-TENSION TENDONS BE DAMAGED (OR ANY OTHER APPLICABLE UNFORESEEN CONDITIONS ARISE) WHILE CONTRACTOR IS PERFORMING AT CONTRACTOR'S OWN RISK, THEN CONTRACTOR SHALL REPAIR ALL DAMAGED TENDONS OR PERFORM OTHER APPLICABLE WORK (INCLUSIVE OF ANY COSTS ASSOCIATED WITH PROVISION OF SHORING, TRAFFIC CONTROL, ETC.) AT NO ADDITIONAL COST TO OWNER.
- 4. THE SUPPORTED CONCRETE SLAB SHALL BE SHORED AS REQUIRED PRIOR TO THE START OF CONCRETE DEMOLITION. SHORING MUST BE DESIGNED AND STAMPED BY A PROFESSIONAL ENGINEER REGISTERED IN THE STATE OF CONNECTICUT. SHOP DRAWINGS OF THE SHORING DESIGN SHALL BE SUBMITTED TO THE ENGINEER FOR REVIEW AND APPROVAL PRIOR TO CONC. REMOVAL.
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- 6. WORK SHALL INCLUDE ADDRESSING ANY SHALLOW-DEPTH DEVIATIONS IN THE CONCRETE SURFACE. THESE SHALLOW-DEPTH REPAIR LOCATIONS, INCLUDING REMOVAL OF OBSTRUCTIONS TO THE LEVEL SURFACE (SUCH AS ABANDONED PIECES OF CONDUIT, FORMER ANCHORS, ETC.) SHALL TYPICALLY BE CONSIDERED ADDRESSABLE BY INSTALLATION OF A LEVELING COURSE IN ACCORDANCE WITH THE MANUFACTURER'S RECOMMENDATIONS; ALL LOCATIONS SHALL BE REVIEWED BY THE MANUFACTURER AND APPROVED BY THE ENGINEER PRIOR TO START OF WORK (TO CONFIRM ABANDONMENT AS APPLICABLE).

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- 10. CONTRACTOR SHALL INSTALL FULL HEIGHT PARTITIONS AROUND AND BELOW ALL WORK AREAS WHERE DEMOLITION AND SUBSEQUENT CONCRETE REPAIRS ARE BEING PERFORMED. PARTITIONS SHALL BE CONSTRUCTED TO PREVENT BOTH DUST AND FALLING DEBRIS FROM LEAVING THE CONFINES OF THE WORK AREA AS WELL AS TO PROVIDE NOISE ABATEMENT. PARTITIONS SHALL BE CONFIGURED TO ATTENUATE NOISE IN THE GARAGE, THROUGH THE USE OF QUILTED INSULATION BLANKETS, AND TO PREVENT UNAUTHORIZED ACCESS INTO ACTIVE WORK AREAS. PARTITION SYSTEMS SHALL BE CONSTRUCTED OF 2 X 4 STUDS AND A MINIMUM OF 3/8" PLYWOOD PANELS, 48" HIGH WITH PLASTIC SHEETING INSTALLED TO THE DECK ABOVE. THE PARTITION SYSTEMS SHALL BE FIRE—RATED AND ALL EXPOSED (EXTERIOR) PLYWOOD SURFACES SHALL BE PAINTED WHITE.
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- 12. FOLLOWING COMPLETION OF MEMBRANE WORK, CONTRACTOR SHALL APPLY NEW MARKINGS FOR ALL PARKING STALLS, DIRECTIONAL ARROWS, CROSSWALKS, CURBS, CENTERLINES, TEXT AND OTHER TRAFFIC MARKINGS LOCATED THROUGHOUT THE GARAGE. APPLICATION OF STRIPING SHALL TYPICALLY BE PERFORMED TO MATCH PRE-EXISTING CONDITIONS OR AS OTHERWISE DIRECTED BY THE ENGINEER, HOWEVER ALL HANDICAP PARKING STALLS SHALL BE VERIFIED PRIOR TO START OF WORK; ALL CURBINGS SHALL BE PAINTED, BOTH THOSE CURRENTLY PAINTED AND THOSE NOT. ANY AND ALL CONFLICTING MARKINGS SHALL BE REMOVED IN THEIR ENTIRETY BY APPROVED METHOD. OWNER/ENGINEER SHALL BE REQUIRED TO REVIEW STRIPING LAYOUT PRIOR TO THIS WORK BEING PERFORMED.

Drawing Title SIXTH LEVEL FLOOR PLAN			STATE OF CONNECTICUT CAPITAL REGION DEVELOPMENT AUTHORITY	
Revision	IS			
No.	Date	Description	Plans Prepared By: DESMAN Design Management	Date: APRIL 2021 Scale AS NOTED Production Leader -
			CHURCH STREET PARKING GARAGE RENOVATIONS & IMPROVEMENTS HARTFORD, CONNECTICUT	Project Manager: - Project Architect: - Peer Reviewer: - Drawing Number
CAD Numb	er:		Project Number: 21-016	R-1.6

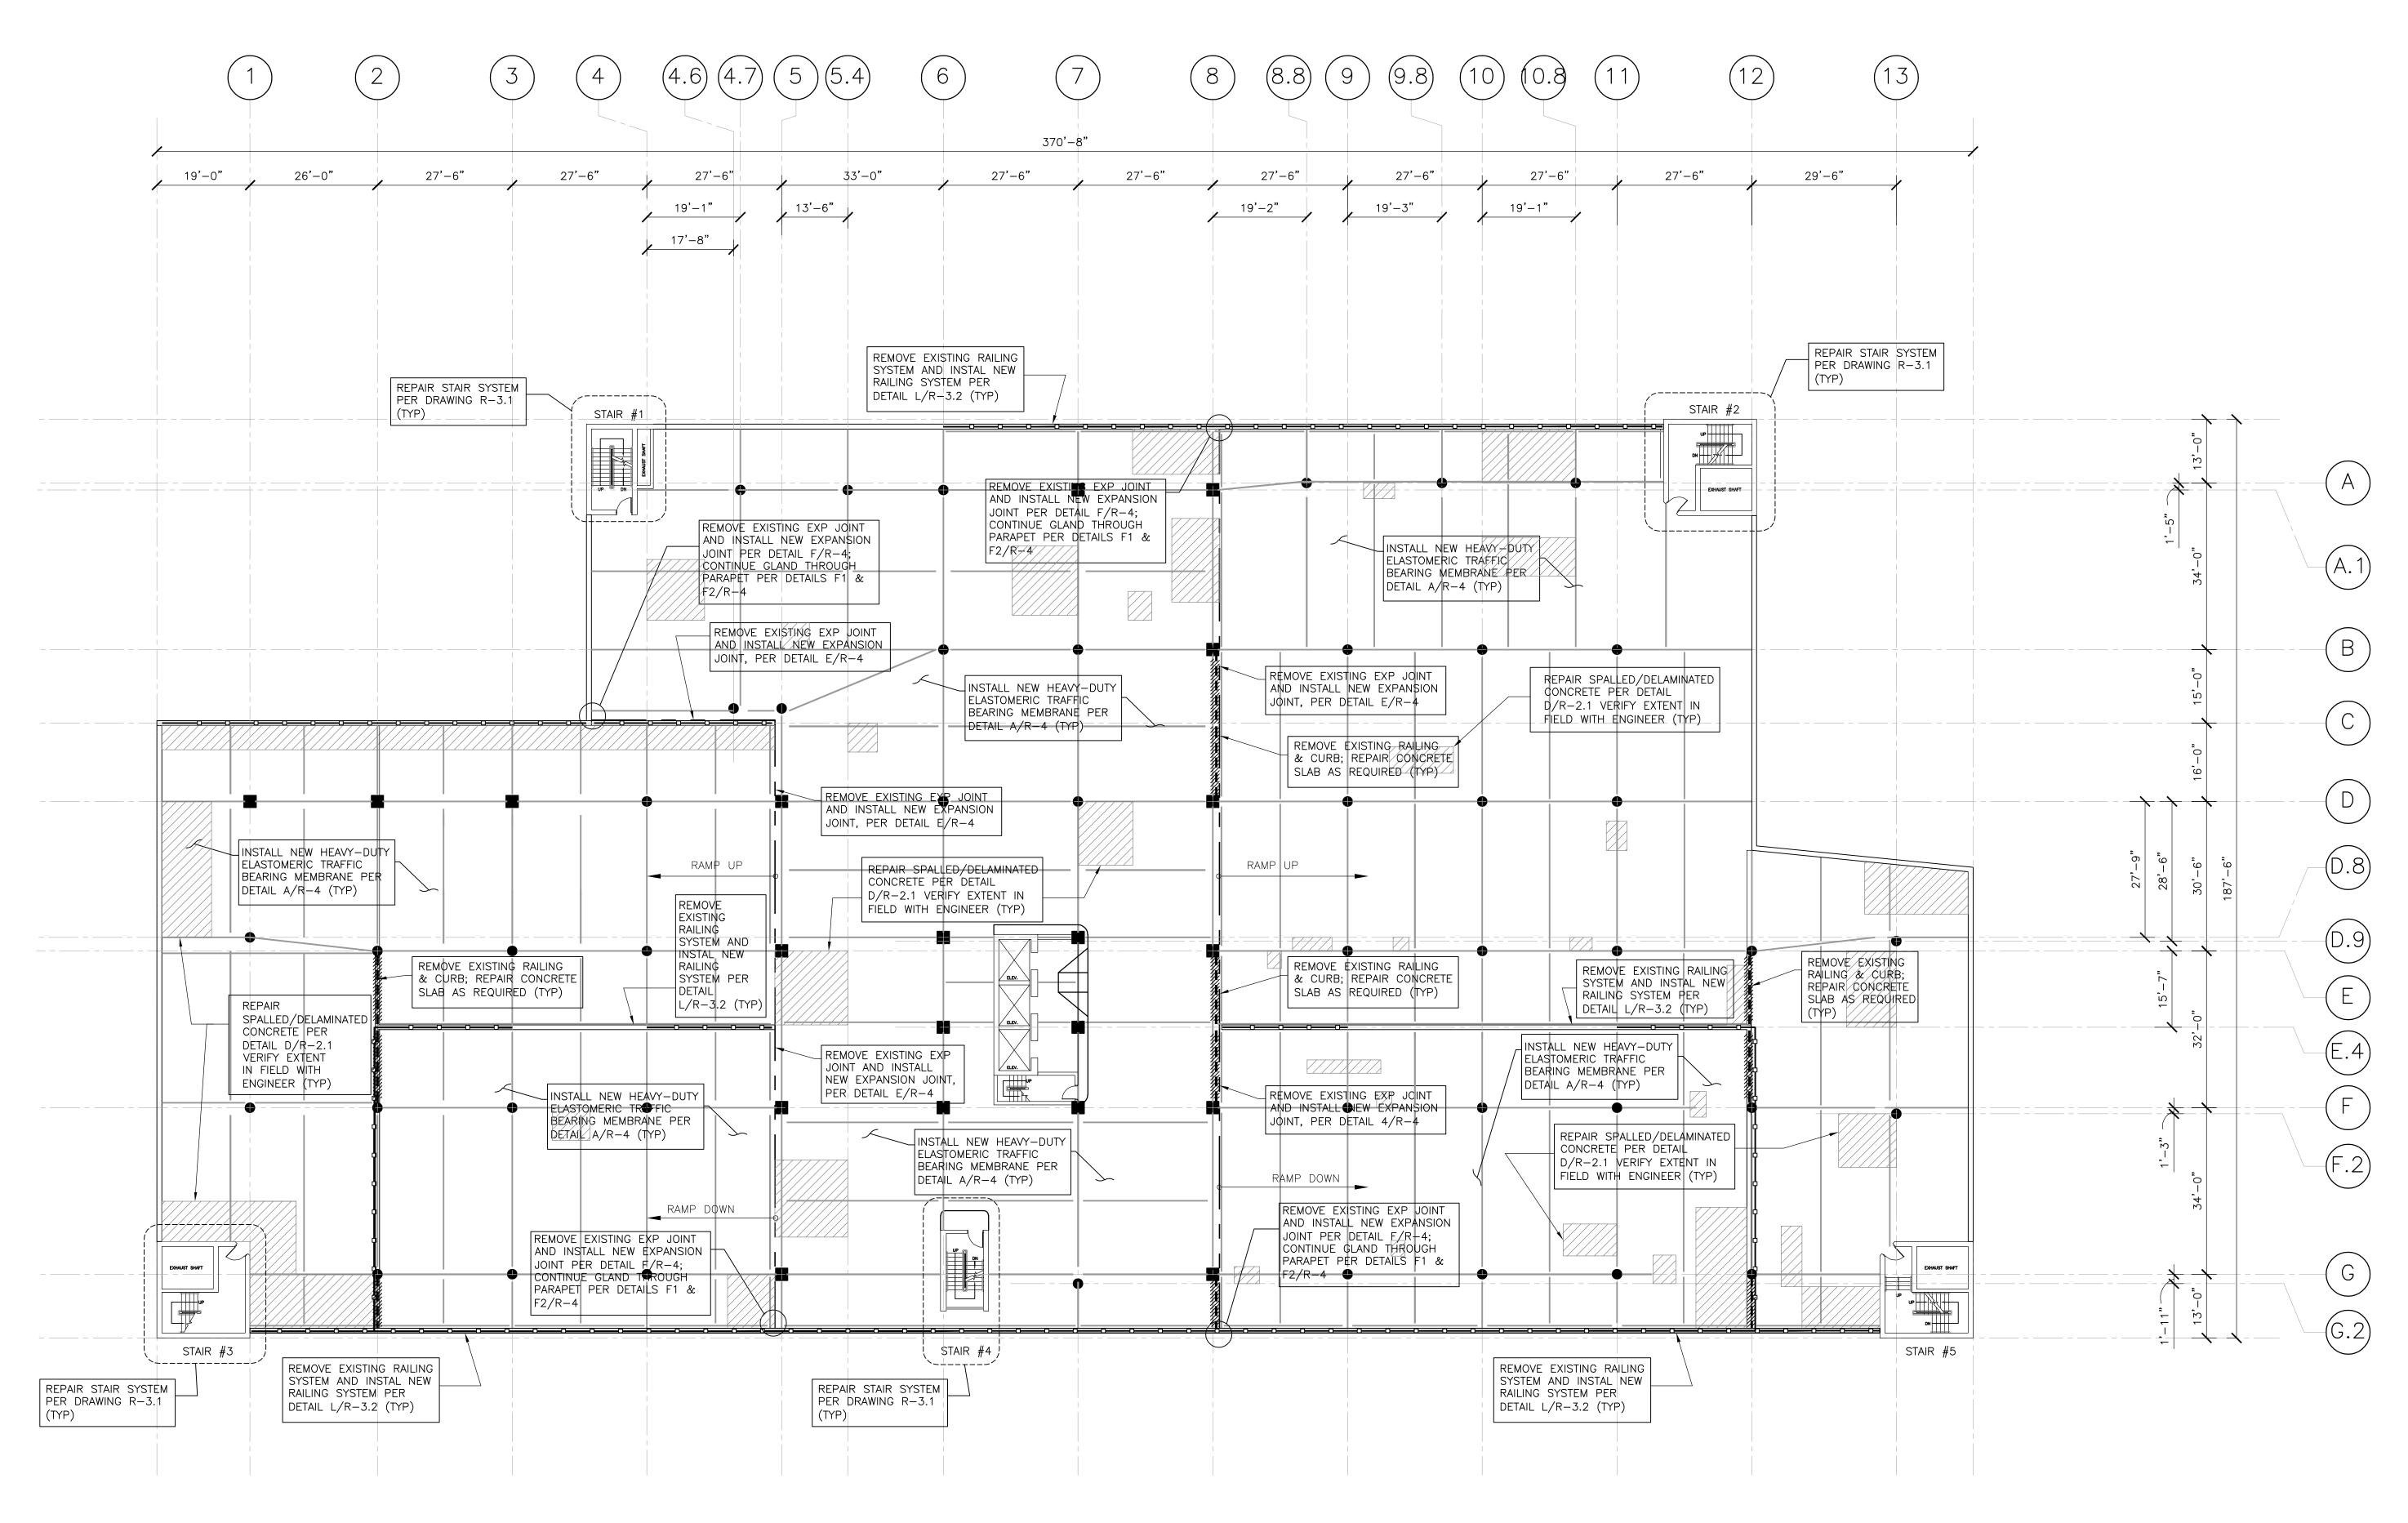

SEVENTH (ROOF) LEVEL FLOOR PLAN SCALE: 1/16"=1'-0"




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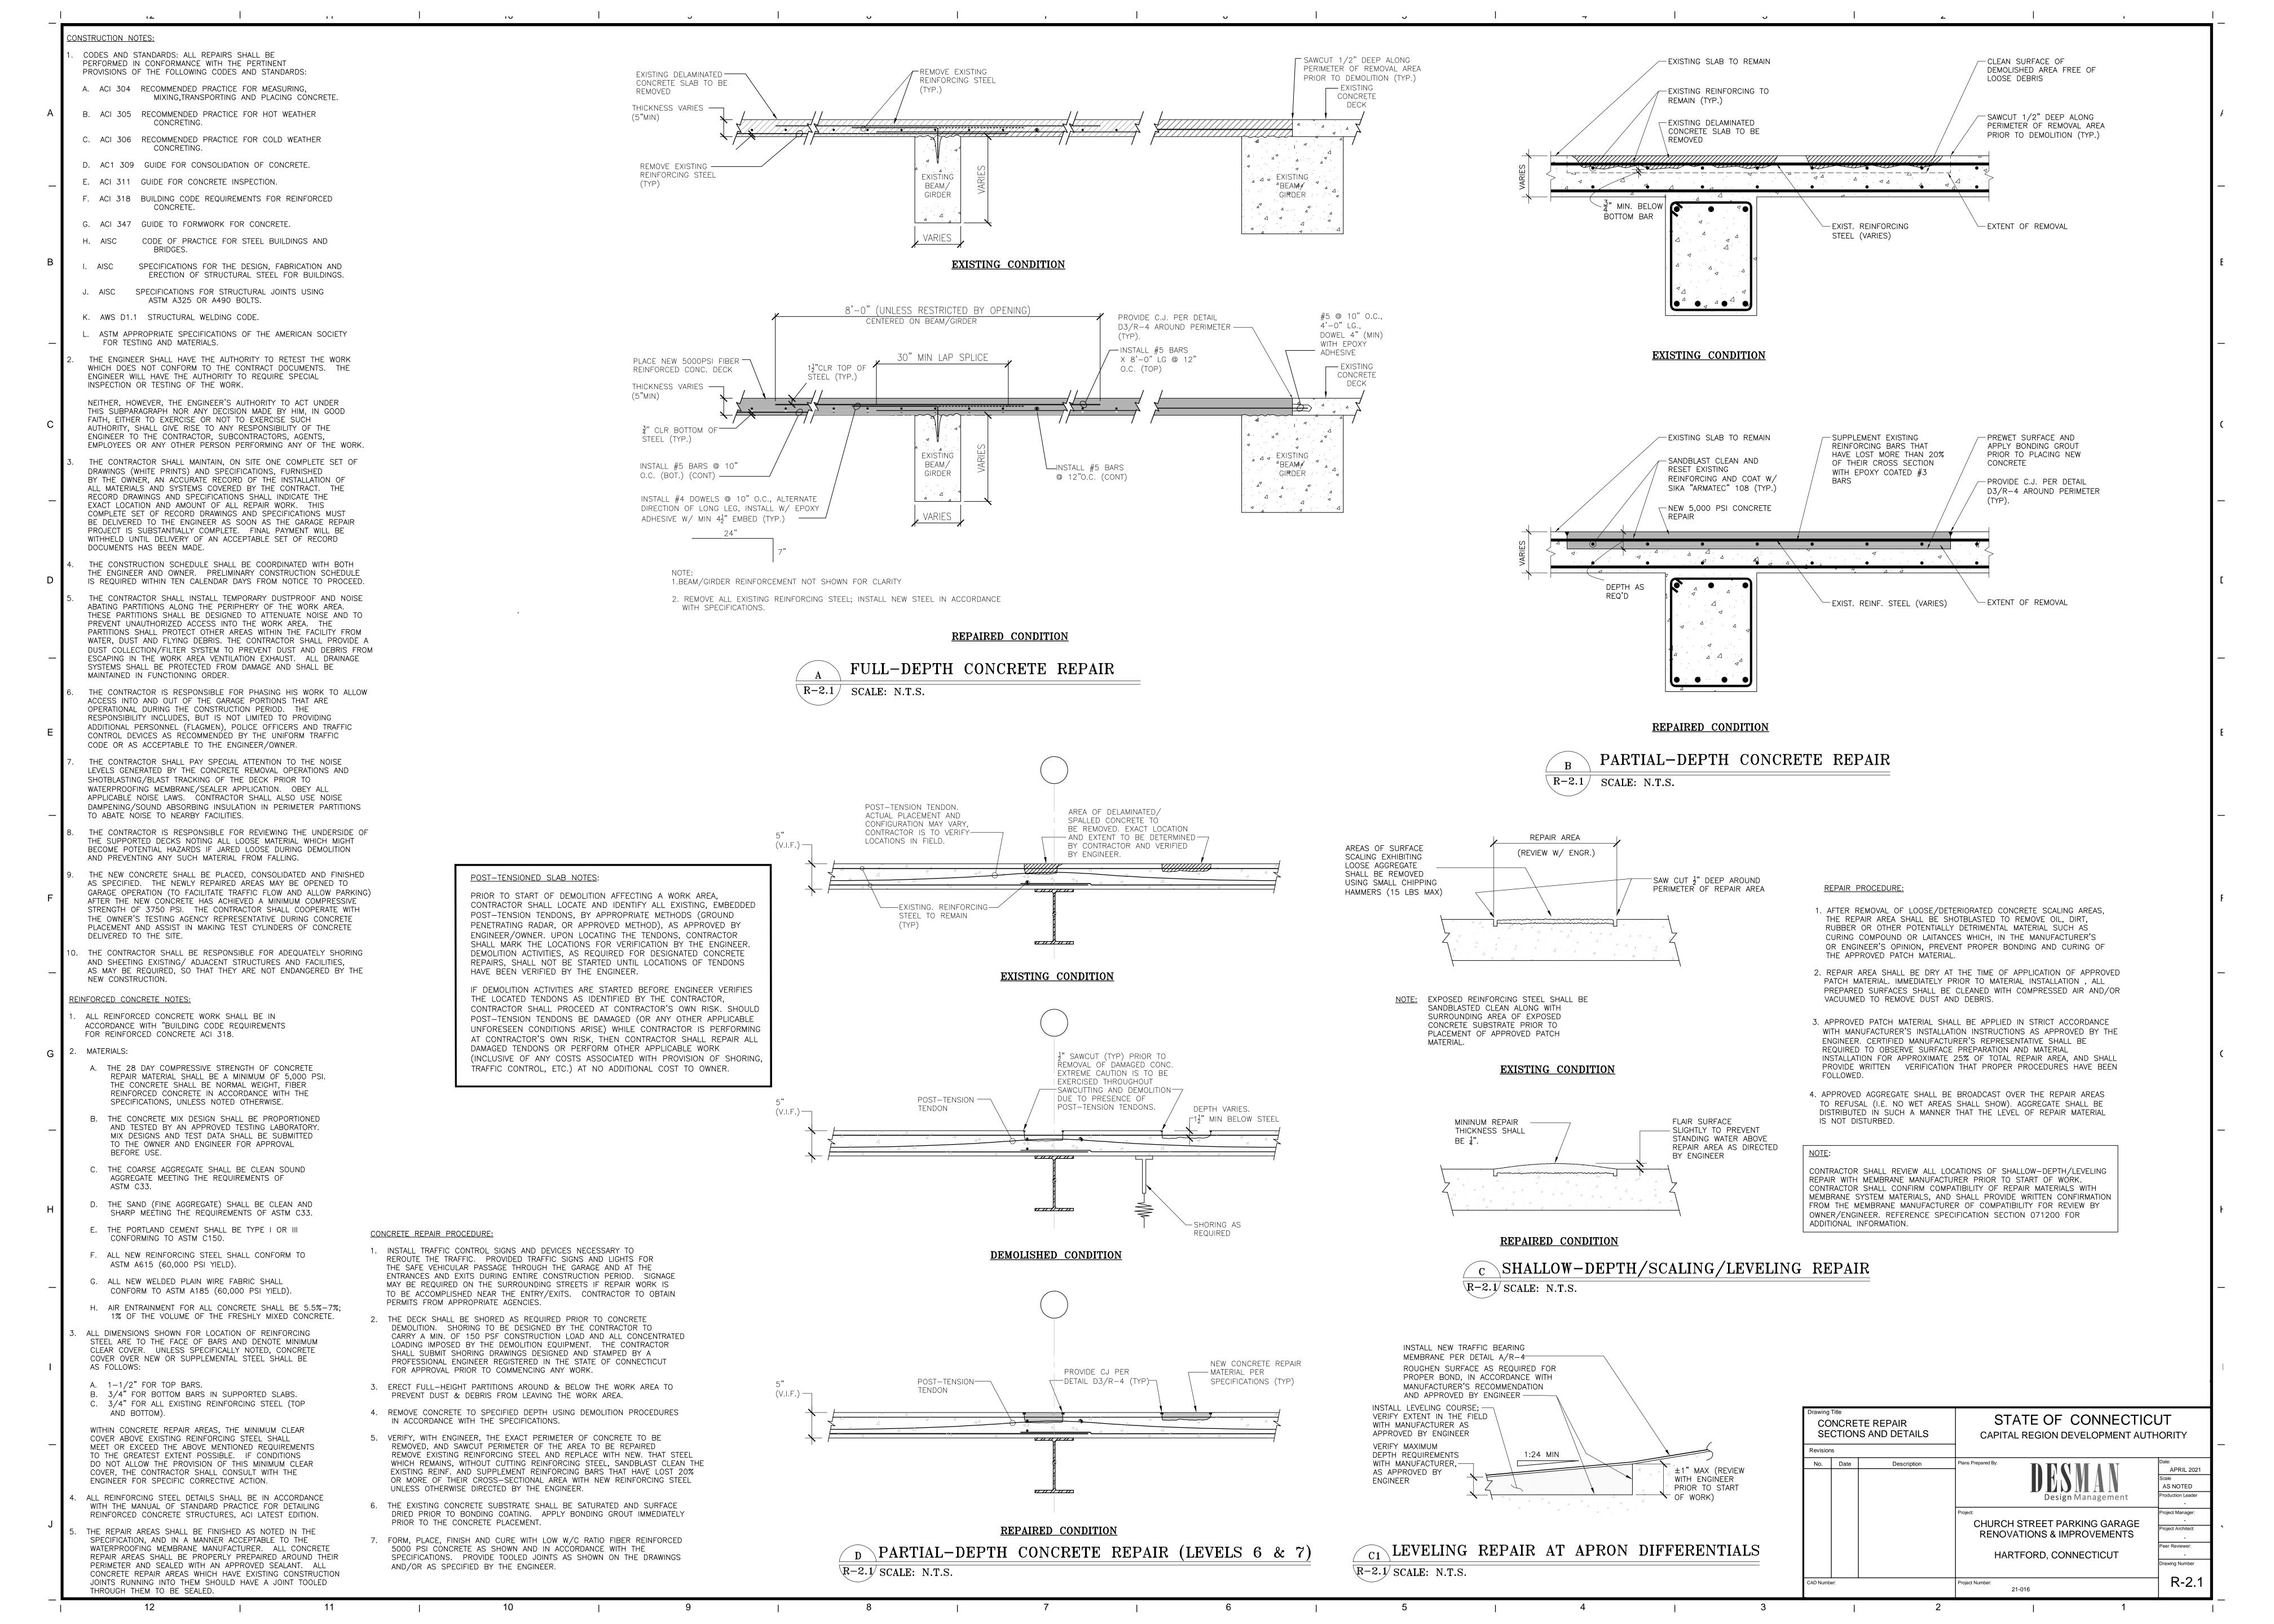
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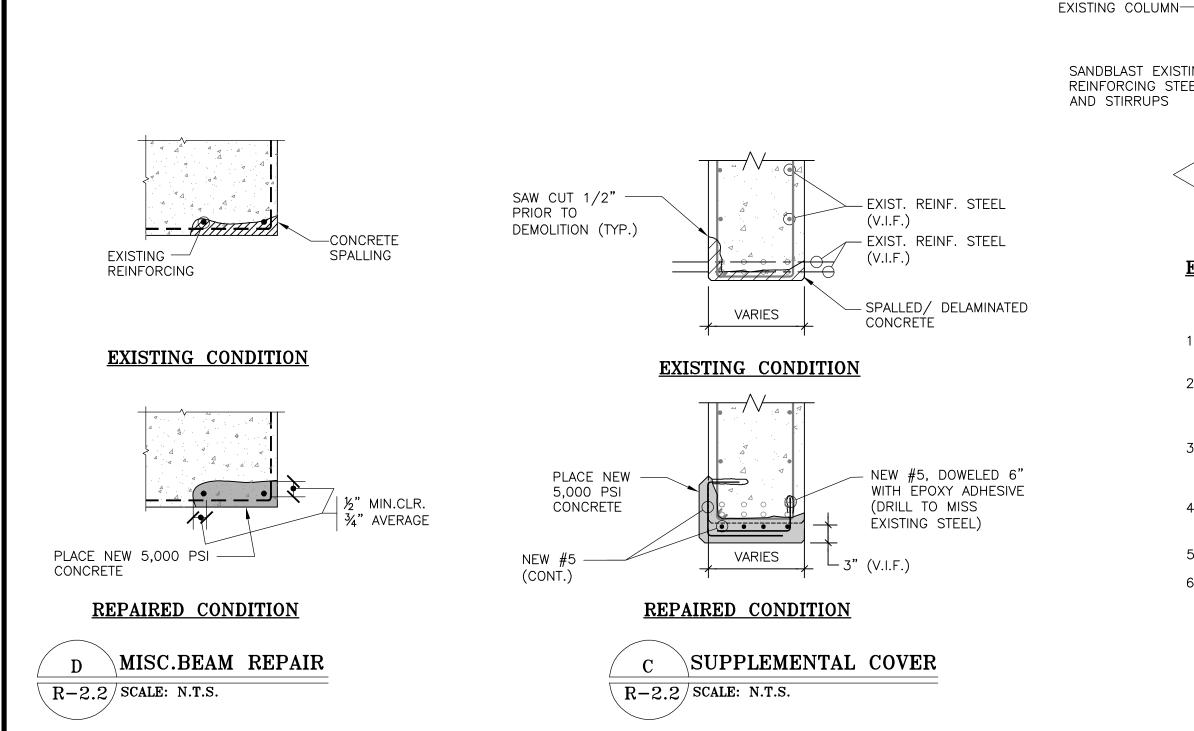
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1. ALL REINFORCED CONCRTEE WORK SHALL BE IN ACCORDANCE WITH "BUILDING CODE REQUIREMENTS FOR REINFORCED CONCRETE ACI 318."

2. CONTRACTOR SHALL NOTE THAT EXTENTS OF REPAIR WORK SHALL BE

VERIFIED WITH THE ENGINEER PRIOR TO START OF WORK.

DETERMINED IN THE FIELD BY THE CONTRACTOR AND REVIEWED AND

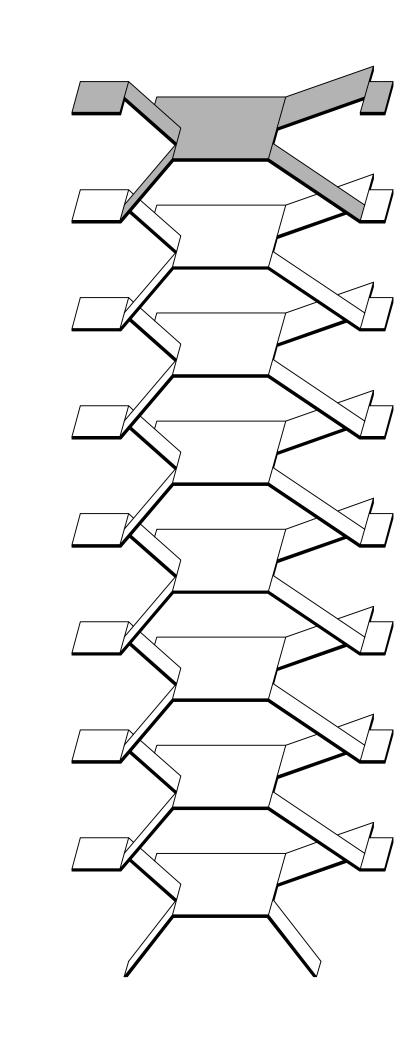3. CONTRACTOR SHALL VERIFY ALL STEEL REQUIREMENTS PRIOR TO START OF

WORK. CONTRACTOR SHALL NOTE THAT SIZING AND PLACEMENT OF EXISTING

AND VERIFIED WITH THE ENGINEER. PLACEMENT AND SIZING OF NEW STEEL

MAY NEED TO BE ADJUSTED UPON VERIFICATION OF EXISTING CONDITIONS.

4. EXTENT OF REPAIRS SHOWN IS SCHEMATIC IN NATURE AND MAY BE ADJUSTED IN THE FIELD UPON REVIEW AND VERIFICATION WITH THE ENGINEER. CERTAIN EXTENTS MAY BE EXPANDED IN ORDER TO ACHIEVE

APPROPRIATE LAPPING OF STEEL AND/OR COVERAGE OF STEEL.

OTHERWISE BY THE ENGINEER.

5. CONTRACTOR SHALL NOTE THAT REPAIRS TO LEDGER BEAMS SHALL NOT

EXCEED 30% OF THE LENGTH OF THE BEAM, UNLESS DIRECTED/APPROVED

STEEL MAY VARY FROM THAT DEPICTED AND THEREFORE SHALL BE REVIEWED

<u>NOTES:</u>

PLACE TROWEL APPLIED CONCRETE-REPAIR MORTAR; ALL REPAIRS SHALL BE SQAURE AND TRUE. SANDBLAST EXISTING REINFORCING STEEL -REMOVE ALL DELAMINATED/SOUND AND STIRRUPS CONCRETE IN ACCORDANCE WITH THE SPECIFICATIONS. EXISTING CONDITION REPAIRED CONDITION

SPLICED OR MECHANICALLY CONNECTED, AS APPROVED BY ENGINEER, TO EXISTING.

CURE AND PROTECT FINISHED REPAIR.

REPAIR PROCEDURE: REMOVE UNSOUND AND SOUND CONCRETE AS DIRECTED BY THE ENGINEER TO A DEPTH OF 1/2" BEHIND EXISTING

REINFORCING USING CHIPPING HAMMERS AND SANDBLAST CLEAN EXPOSED STEEL. ALL REPAIRS SHALL BE SQUARE AND

CLEAN SURFACE OF DEMOLITION AREA FREE OF LOOSE DEBRIS. SUPPLEMENT EXISTING REINFORCING BARS THAT HAVE

LOST MORE THAN 20% OF THEIR ORIGINAL CROSS SECTION WITH NEW BARS. NEW REINFORCING SHALL BE PROPERLY LAP


2" MINIMUM (TYP) —

CONTRACTOR SHALL APPLY ZINC-RICH PRIMER TO ALL STEEL, NEW AND EXISTING/EXPOSED. COVERAGE SHALL BE REVIEWED IN THE FIELD BY THE ENGINEER PRIOR TO CONCRETE PLACEMENT; CONCRETE PLACEMENT MAY BE DELAYED

UNTIL PRIMER COVERAGE IS DETERMINED TO BE ACCEPTABLE BY ENGINEER. APPLY NON SAG REPAIR MORTAR IN LAYERS AS PER MANUFACTURER'S REPAIR PROCEDURE OR FORM AND PUMP REPAIR. LAYERS SHALL BE LIMITED IN THICKNESS. EXISTING CONCRETE SURFACE SHALL BE PREWET PRIOR TO APPLICATION.

NEW REPAIR MATERIALS SHALL MATCH EXISTING MATERIAL FINSHES IN FINISHED APPEARANCE INCLUDING, BUT NOT LIMITED TO COLOR, TEXTURE, AND ANY EXISTING ARCHITECTURAL COATINGS. COORDINATE APPLICATION OF NEW COATINGS AS




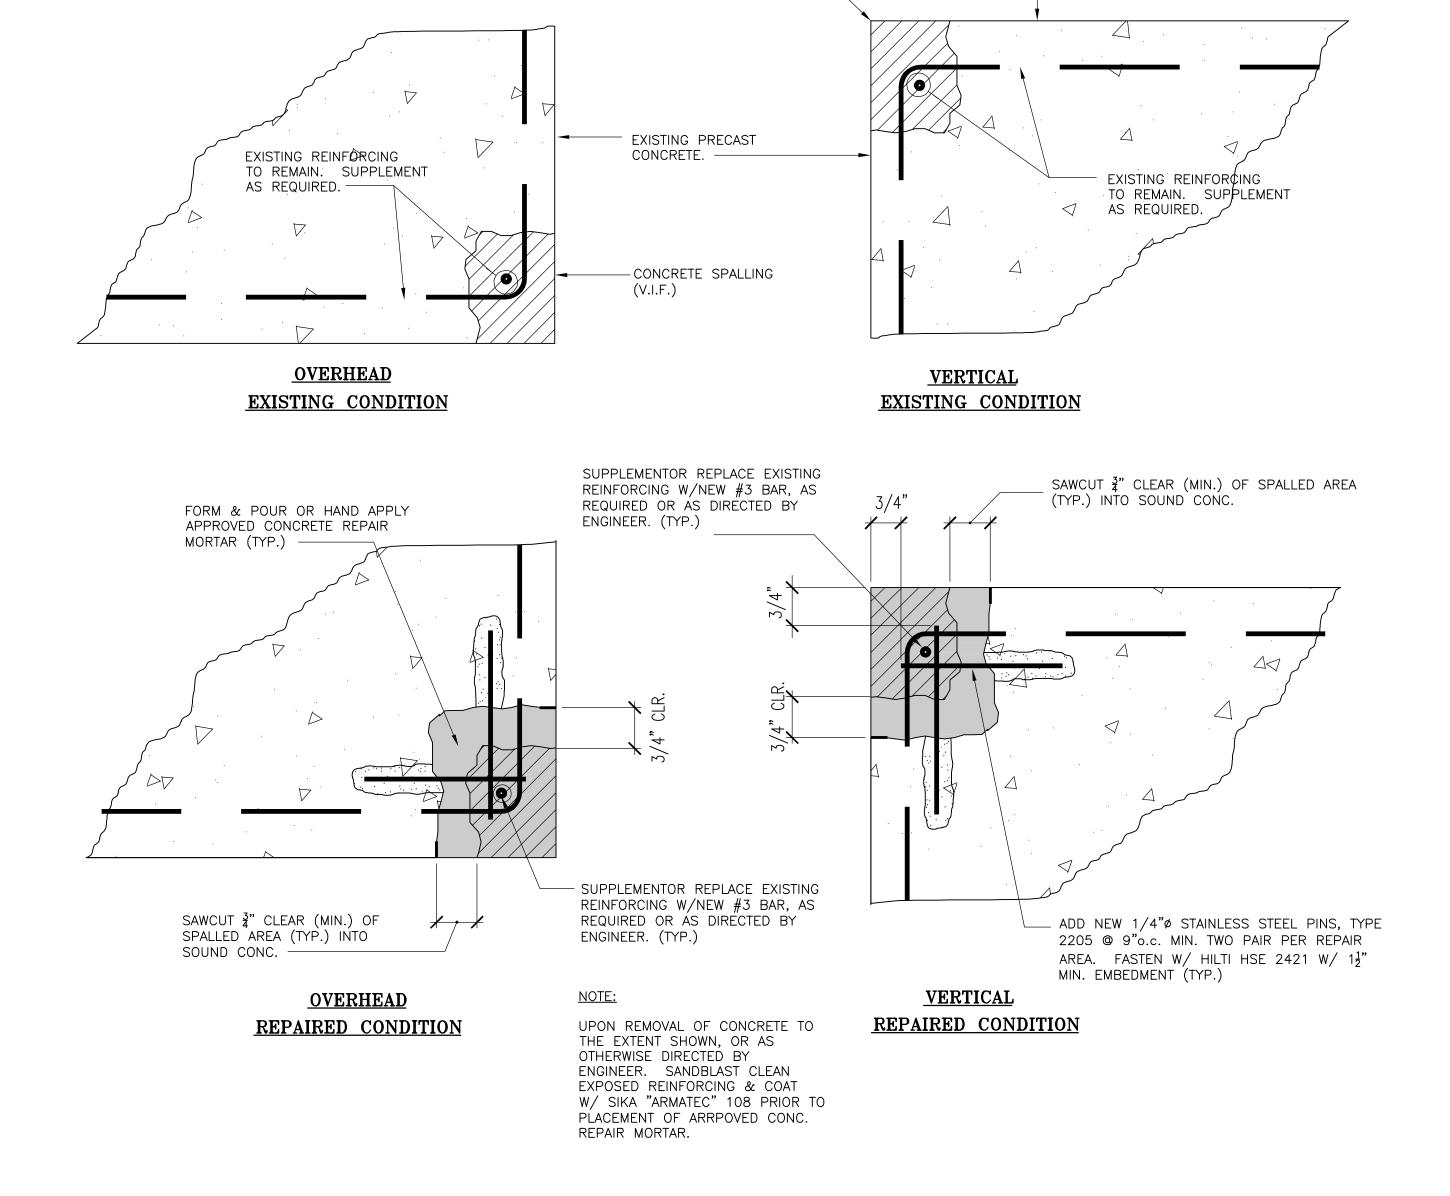


CONCRETE SPALLING

(V.I.F.) ——

VERTICAL/OVERHEAD CONCRETE REPAIR $\overline{R-2.2/SCALE}$: N.T.S.

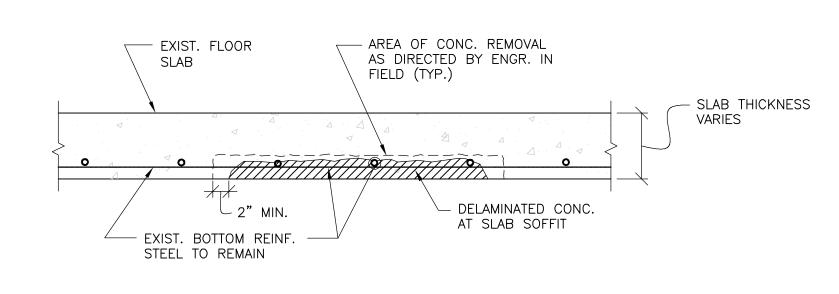

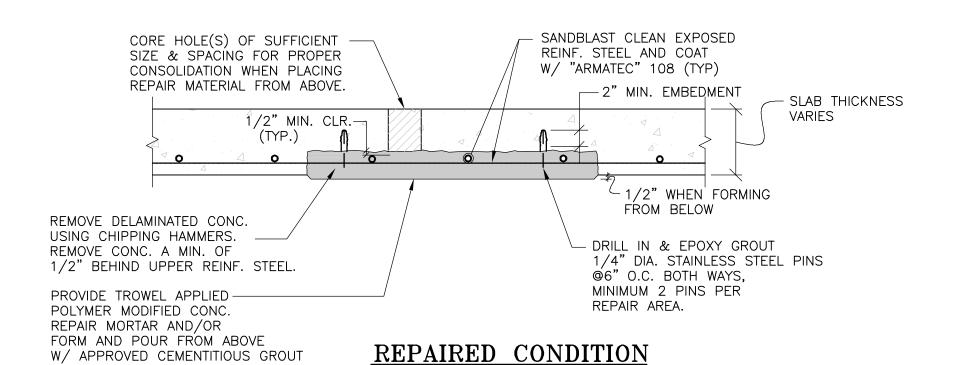

EXISTING PRECAST

CONCRETE.

EXISTING CONDITION

REPAIR PROCEDURE:

- A. PRIOR TO PROCEEDING WITH ANY AND ALL OVERHEAD CONCRETE DECK REPAIRS THE CONTRACTOR SHALL FIRST REVIEW THE CONDITION OF THE UPPER SURFACES OF THE DECK TO DETERMINE IF DECK REPAIRS MIGHT ENTAIL FULL DEPTH DECK REPAIR, OR ALTERNATELY ONLY PARTIAL DEPTH REPAIR. TYPICALLY WITHIN THIS FACILITY AREAS REQUIRING OVERHEAD REPAIR ARE ASSOCIATED WITH DETERIORATED CONCRETE SURFACES ABOVE. IT IS IMPORTANT THAT ALL DEMOLITION ACTIVITIES ON UPPER CONCRETE SURFACES ARE COMPLETED PRIOR TO STARTING ANY OVERHEAD CONCRETE DEMOLITION AND ASSOCIATED SURFACE PREPARATION BELOW.
- B. TWO ALTERNATIVE OVERHEAD CONCRETE REPAIR OPTIONS ARE ALLOWABLE IN IMPLEMENTING REPAIRS TO OVERHEAD SURFACES. EITHER ONE MAY BE USED AT THE CONTRACTOR'S OPTION, OR A COMBINATION OF THE TWO UTILIZED TO OBTAIN ACCEPTABLE RESULTS. NO COST DIFFERENTIATION SHALL BE ENTERTAINED BETWEEN THE TWO OPTIONS OR A COMBINATION OF THE TWO. THESE TWO ALTERNATIVES ARE:
- 1. OVERHEAD CONCRETE REPAIR USING AND APPROVED TROWEL APPLIED POLYMER MODIFIED OVERHEAD CONCRETE REPAIR MORTAR.
- 2. FORM, PUMP OR POUR CONCRETE REPAIR MORTAR
- C. SAW-CUT PERIMETER OF OVERHEAD REPAIR AREA TO A MINIMUM DEPTH OF 3/8". OVERHEAD REPAIR AREAS SHALL BE SQUARE AND TRUE IN PLAN AS VIEWED FROM BELOW UNLESS OTHERWISE REVIEWED AND APPROVED BY THE ENGINEER.
- D. ALL LOOSE AND UNSOUND CONCRETE SHALL BE REMOVED WITH SMALL CHIPPING HAMMERS TO PROVIDE A MINIMUM 1/4" AMPLITUDE SUBSTRATE PROFILE. UNSOUND CONCRETE SHALL BE REMOVED TO A MINIMUM OF 1/2" BEYOND EXIST. REINFORCING STEEL.
- E. ALL EXPOSED REINFORCING STEEL SHALL BE SANDBLASTED CLEAN AND COATED WITH ZINC-RICH PRIMER (TYP). THE EXPOSED SUBSTRATE SHALL BE BLOWN CLEAN WITH COMPRESSED AIR TO ASSURE THAT ALL LOOSE AND HALLOW CONCRETE HAS BEEN SUCCCESSFULLY REMOVED, AFTER CLEANING AND SANDBLASTING ALL MEASURES MUST BE TAKEN TO PREVENT FLASH RUSTING FROM OCCURRING ON THE EXISTING REINFORCING STEEL.

MATERIAL. CURE AS PER


MANUFACTURER'S RECOMMENDATIONS.

- CONTRACTOR SHALL PROVIDE AND INSTALL 1/4" STAINLESS STEEL PINS (APPROXIMATELY 4" LONG) AT 6" ON CENTER, BOTH WAYS WITHIN THE PREPARED REPAIR AREA. A MINIMUM OF 2 PINS PER REPAIR AREA IS REQUIRED. PINS TO BE EPOXY GROUTED.
- G. CONTRACTOR SHALL SUPPLEMENT EXISTING REINFORCING BARS WHICH HAVE LOST MORE THAN 20% OF THEIR CROSS SECTIONAL AREA WITH NEW EPOXY COATED REINFORCING BARS. NEW BARS SHALL BE PROPERLY LAP SPLICED TO EXISTING BARS, OR EPOXY GROUTED INTO ADJACENT SOUND CONCRETE.
- H. FORMS IF REQUIRED, DEPENDING UPON REPAIR OPTION SELECTED, SHALL BE WATERTIGHT AND SECURED AS NECESSARY TO SUPPORT WET CONCRETE AND TO PREVENT ANY EXCESSIVE DEFLECTION OR BOWING OF THE FORMS. FORMS SHALL BE INSTALLED IN SUCH A WAY SO AS TO PROVIDE A MINIMUM OF 1/2" CHAMFERED EDGE IN COMPARISON TO SURROUNDING OVERHEAD CONCRETE SURFACES. FORMS SHALL BE COATED WITH A SUITABLE FORM RELEASE AGENT TO FACILITATE EASY AND CLEAN REMOVAL AFTER SUFFICIENT
- DEPENDING UPON THE REPAIR OPTION SELECTED, THE CONTRACTOR SHALL PROVIDE ALL NECESSARY CORE HOLES WITHIN THE CONCRETE DECK TO ALLOW FOR EASY PLACEMENT OF PUMP AND POUR REPAIR MORTAR. CORE HOLES SHALL BE OF SUFFICIENT SIZE AND SPACING TO ASSURE PROPER


CONSOLIDATION OF REPAIR MATERIAL WHEN PLACED FROM ABOVE.


SOFFIT (OVERHEAD) CONCRETE REPAIR R-2.2/ SCALE: N.T.S.


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Drawing Title CONCRETE REPAIR SECTIONS AND DETAILS Revisions			STATE OF CONNECTICUT CAPITAL REGION DEVELOPMENT AUTHORITY	
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No.	Date	Description	Plans Prepared By:	APRIL 2021
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				AS NOTED
			Design Management	Production Leader
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			Project:	Project Manager:
			CHURCH STREET PARKING GARAGE	Project Architect:
			RENOVATIONS & IMPROVEMENTS	-
				Peer Reviewer:
			HARTFORD, CONNECTICUT	-
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INSTALLATION OF CONCRETE APRON AT SLAB DIFFERENTIALS R-2.2/ SCALE: N.T.S.

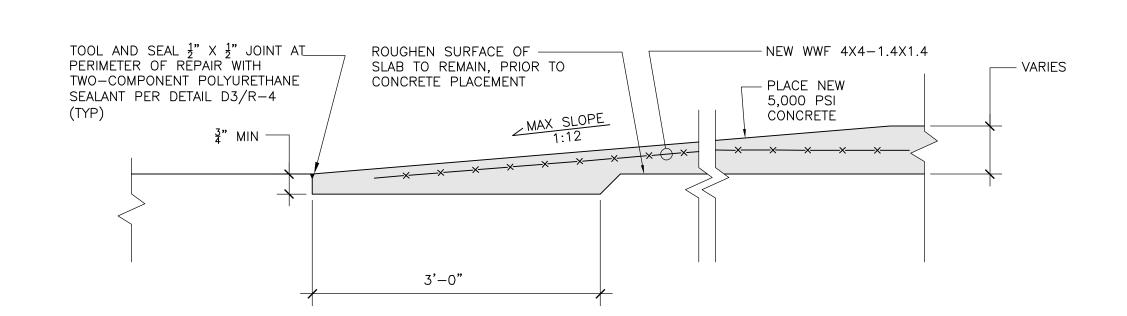



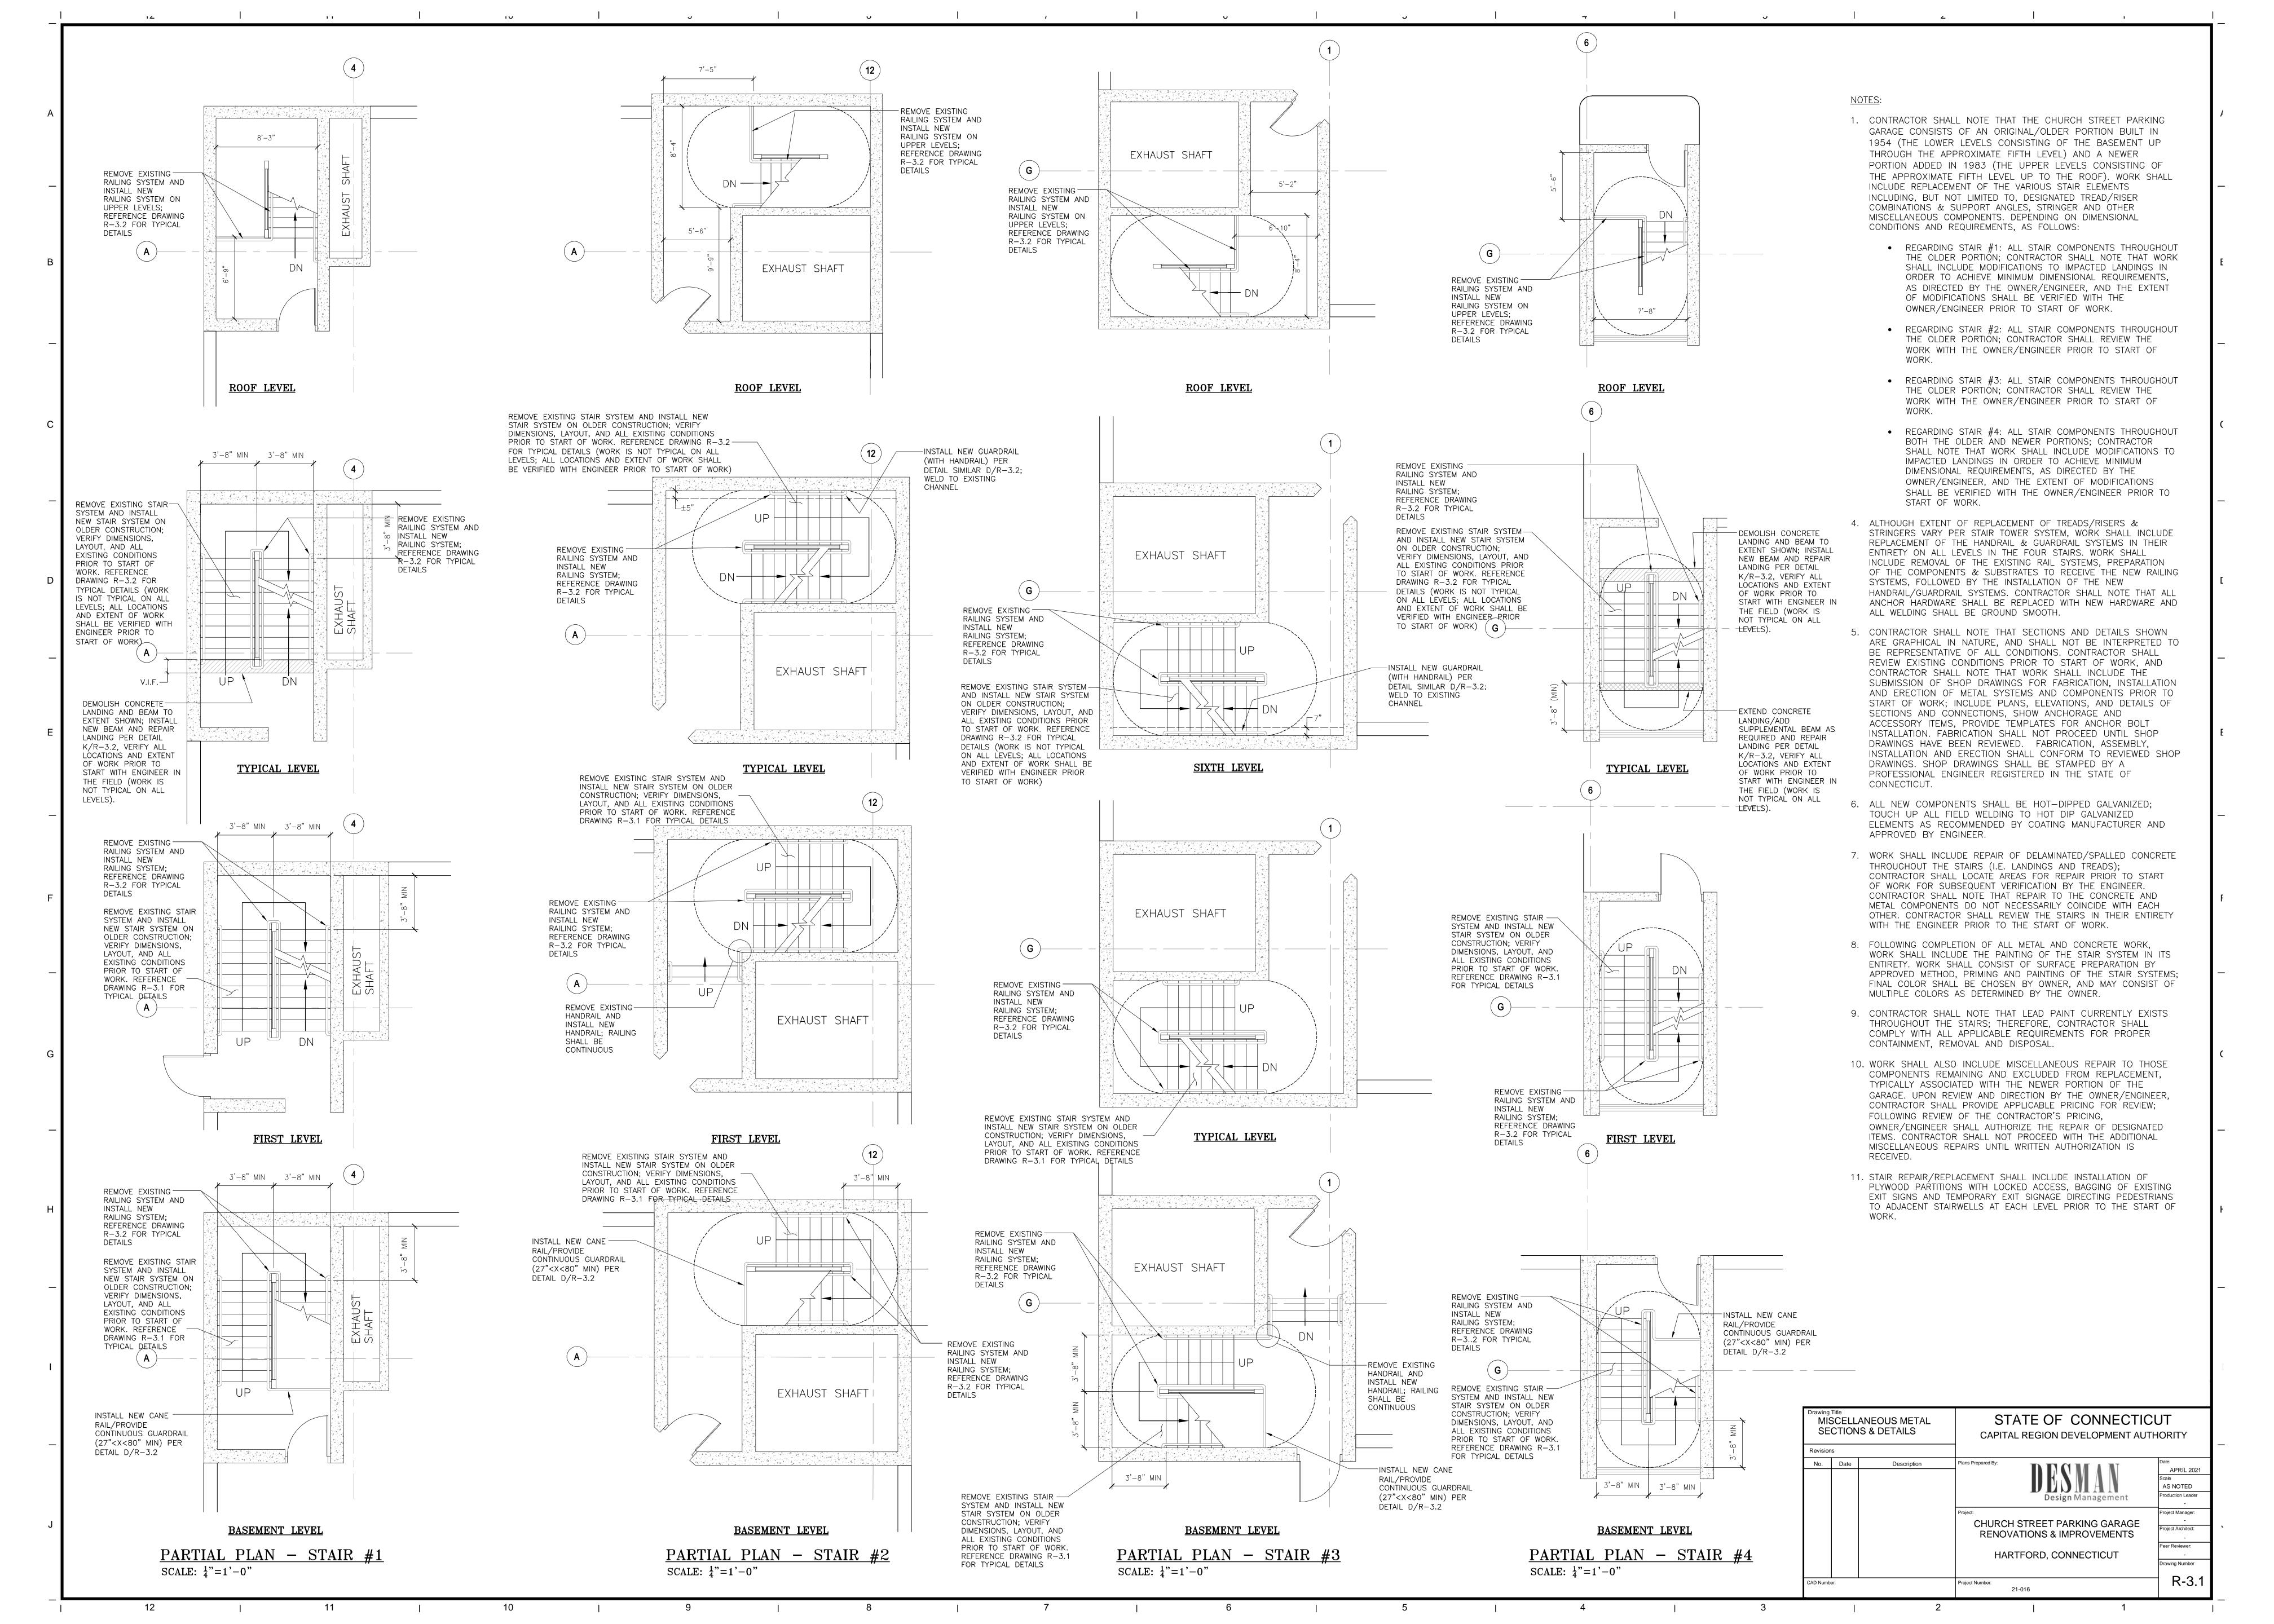

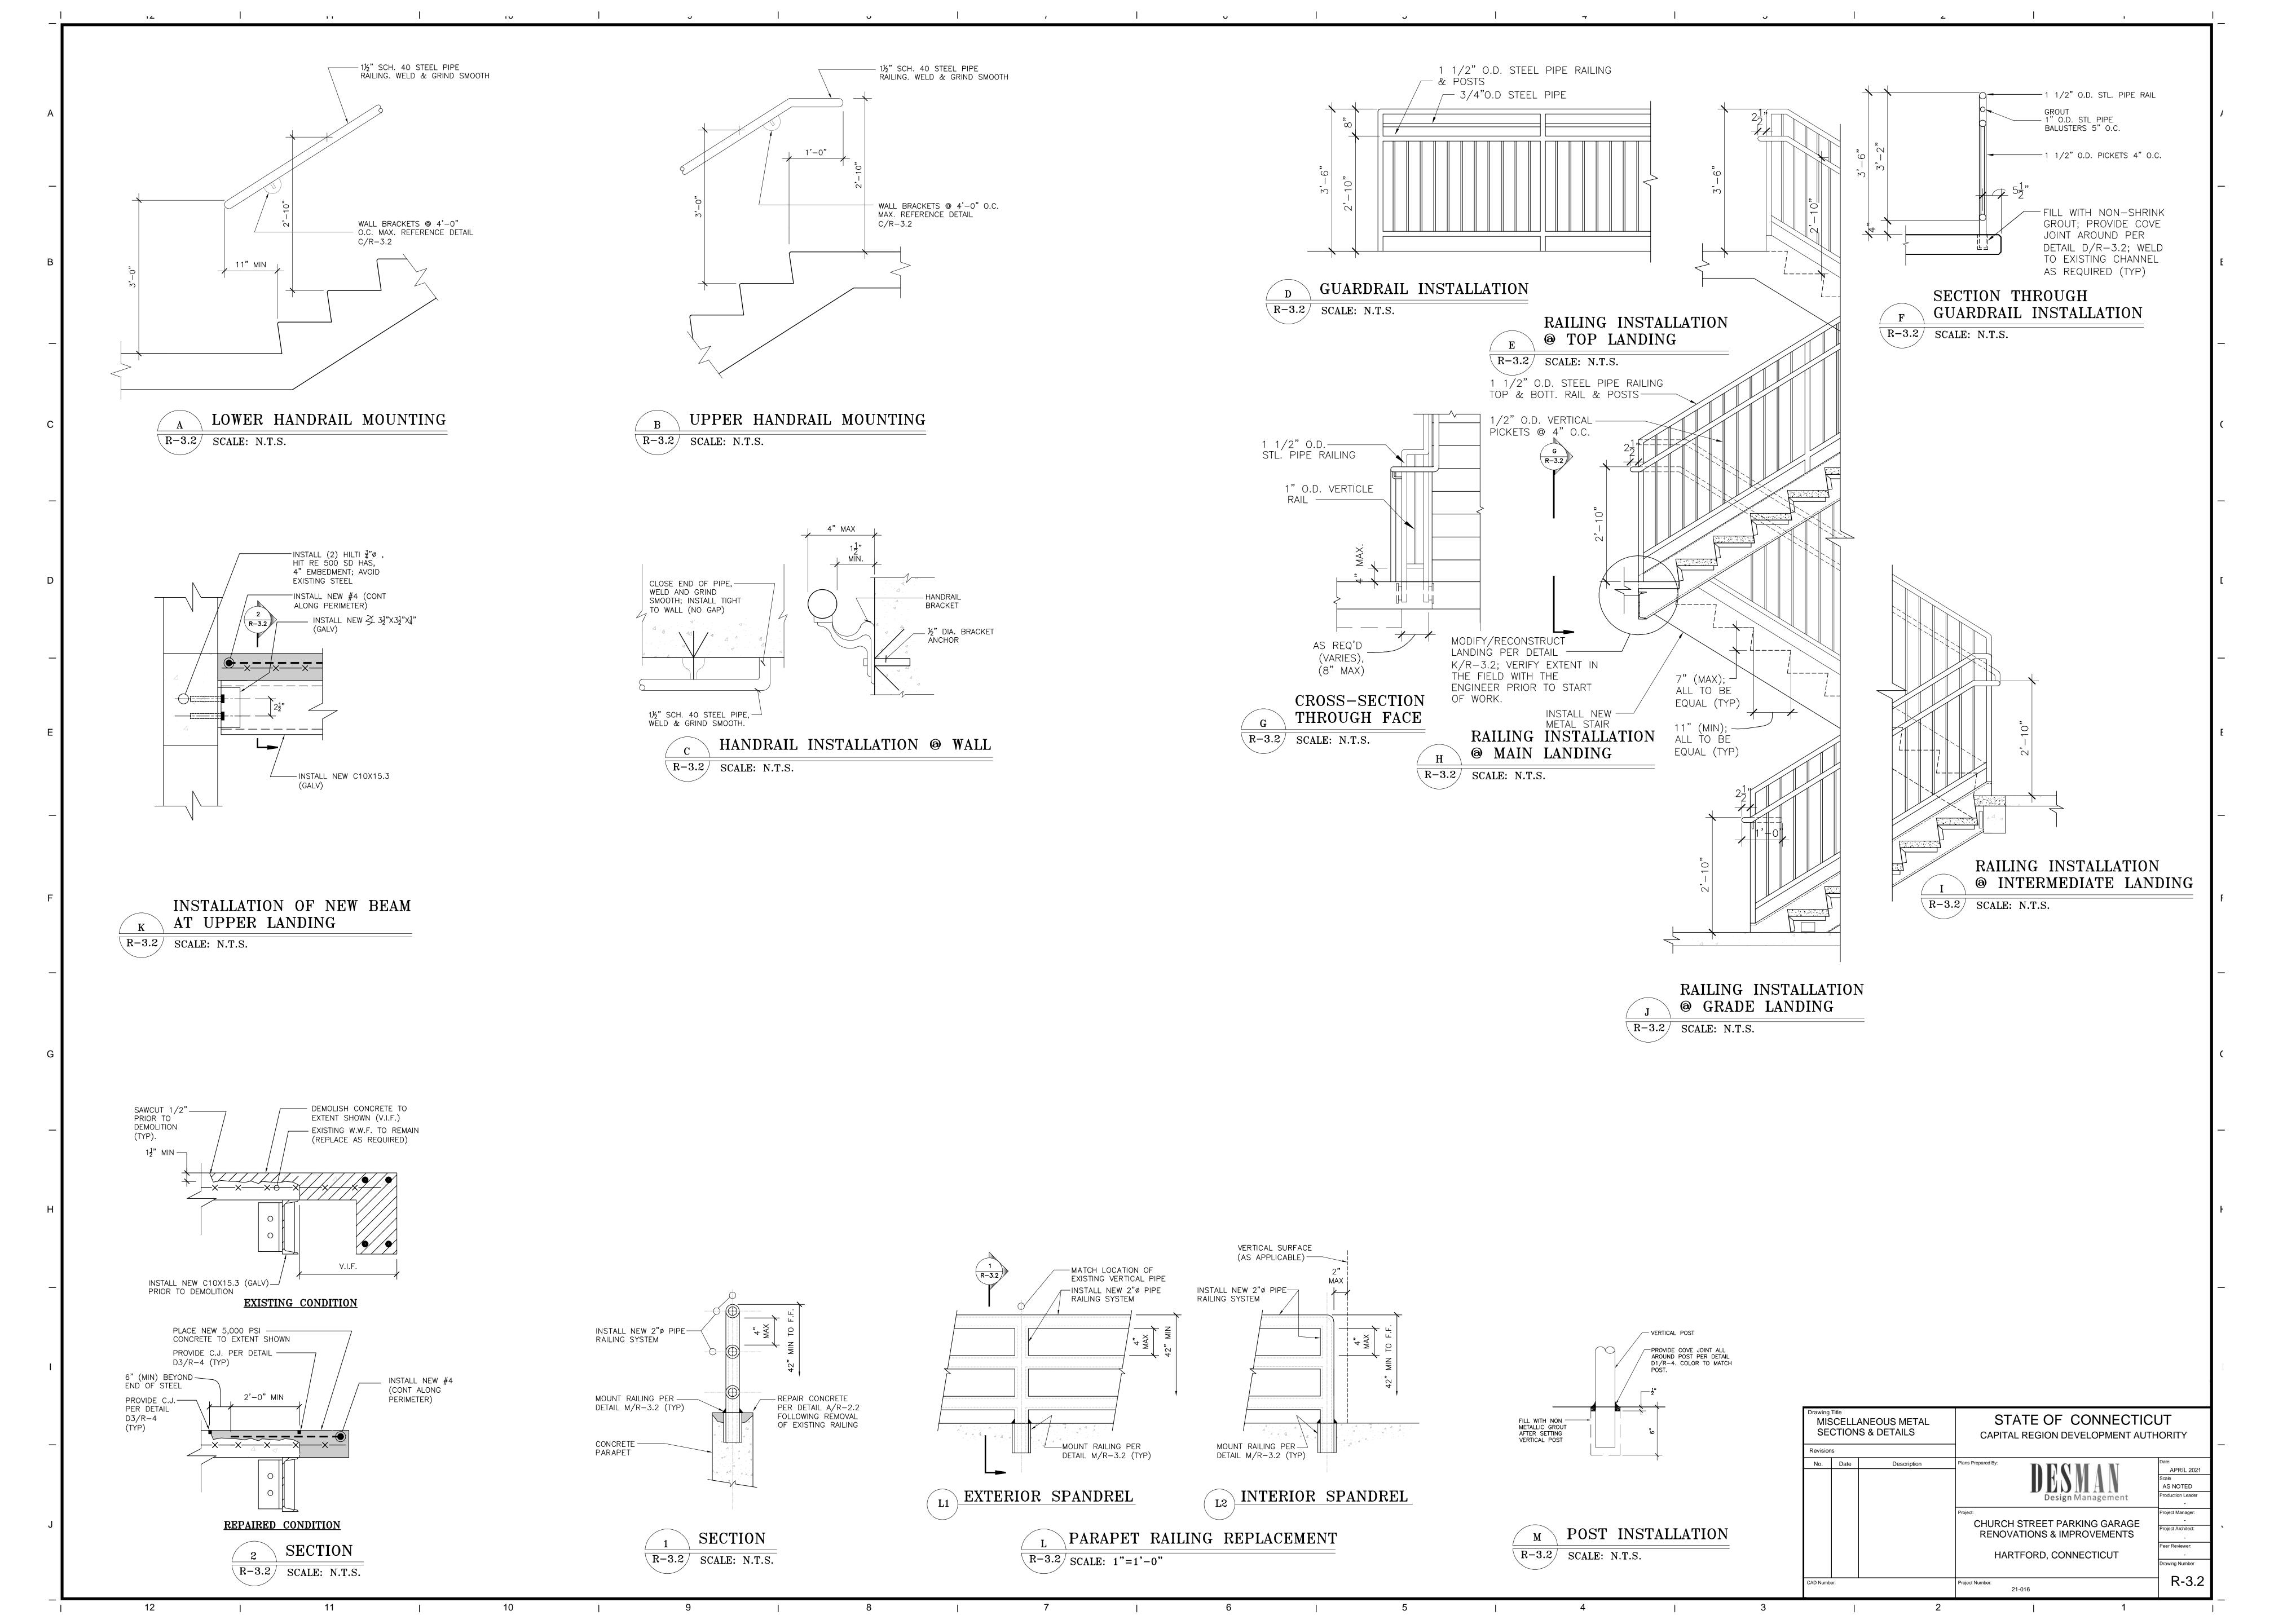DETAIL D1

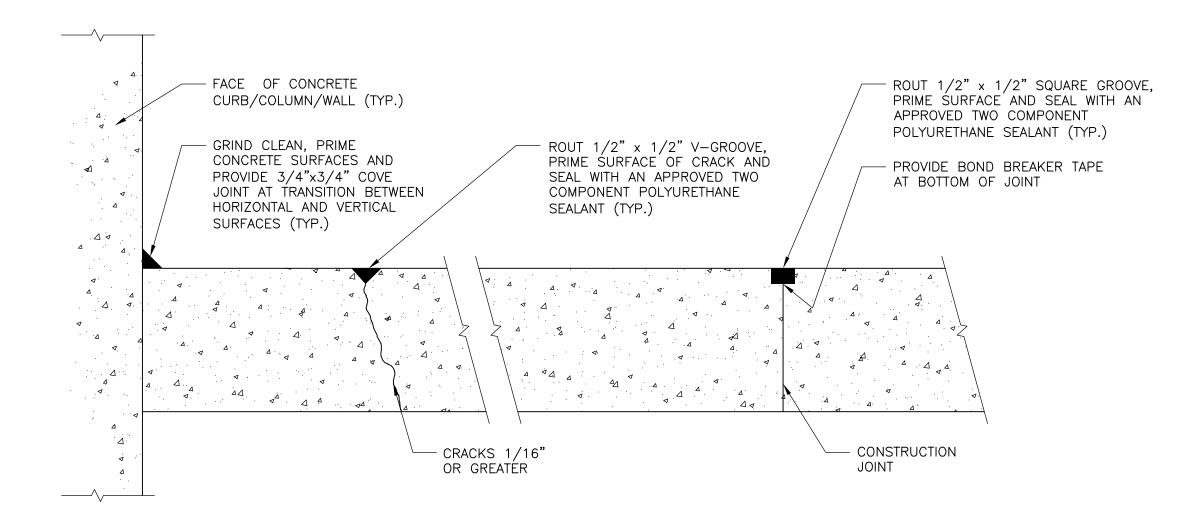
DETAIL D2


DETAIL D3

REPAIR PROCEDURE:

- 1. CONCRETE SURFACES SHALL BE FULLY DRY AND CURED PRIOR TO INSTALLATION OF APPROVED SEALANT MATERIAL
- 2. ROUT/GRIND CRACKS AND JOINTS AS REQUIRED, CLEAN PROFILED SURFACES USING COMPRESSED AIR OR OTHER MEANS TO REMOVE DUST, DEBRIS AND OTHER MATERIAL, WHICH MIGHT IMPAIR THE SEALANT BOND TO THE SUBSTRATE.
- 3. PRIME SURFACES TO RECEIVE SEALANT, PROVIDE BOND BREAKER TAPE (AS REQUIRED) AND SEAL WITH AN APPROVED TWO COMPONENT POLYURETHANE SEALANT AS SHOWN.
- 4. WHERE SEALANT IS TO BE LEFT EXPOSED TOOL TO FORM A CONCAVE PROFILE. WHERE THE SEALANT WILL BE COVERED BY A WATERPROOFING MEMBRANE LEAVE FLUSH WITH FLOOR SURFACE.
- 5. PROHIBIT VEHICULAR AND PEDESTRIAN TRAFFIC ON SEALED JOINTS UNTIL SEALANT MATERIAL HAS CURED ACCORDING TO MANUFACTURER'S RECOMMENDATIONS.

COVE JOINT/CRACK/CONSTRCUTION JOINT

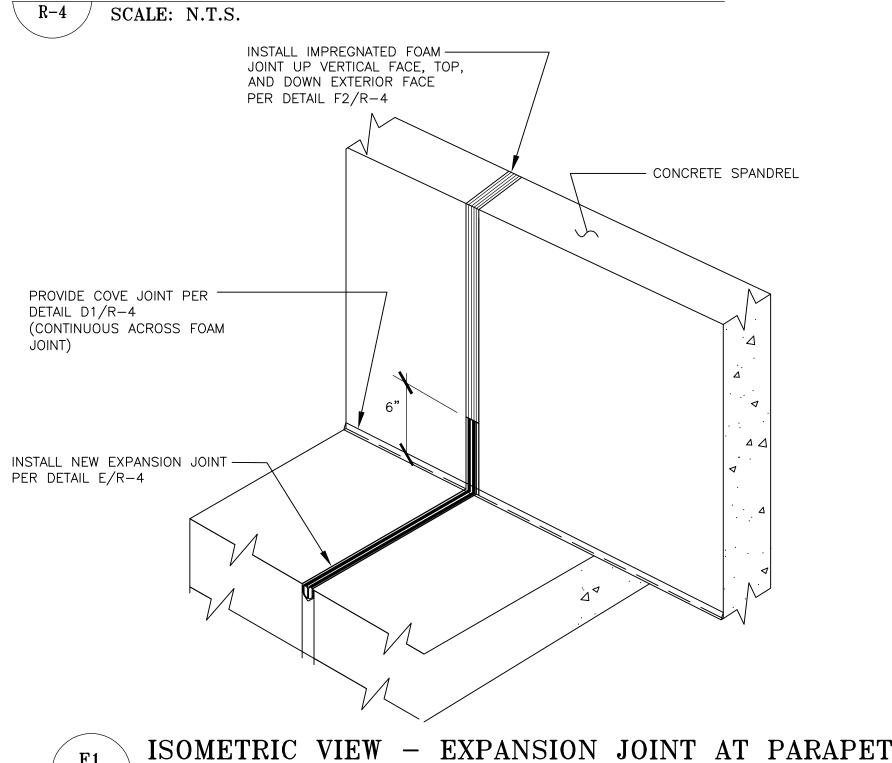

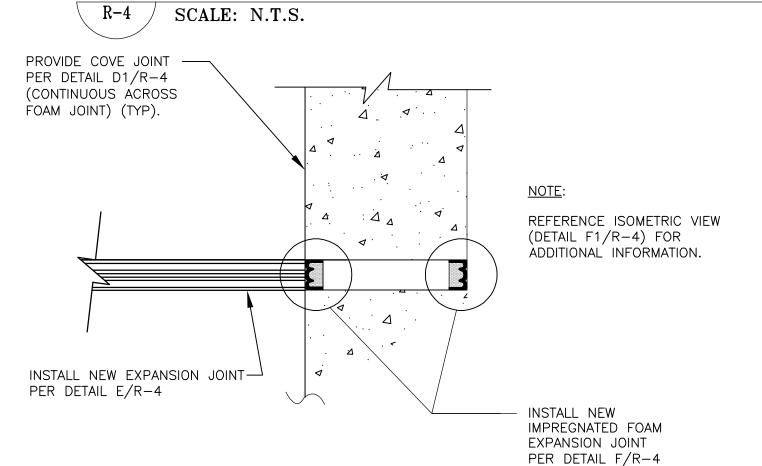



SECTION - EXPANSION JOINT AT PARAPET

 $\overline{R-4}$ SCALE: N.T.S.

EXPANSION JOINT INSTALLATION NOTES:

12


- 1. PREPARE CONCRETE BLOCKOUT TO THE DIMENSION SHOWN OR AS MIGHT OTHERWISE BE REQUIRED BY EXPANSION JOINT MANUFACTURER AND SUBSEQUENTLY APPROVED BY THE ENGINEER.
- 2. SAWCUT, GRIND, OR OTHERWISE PREPARE CONCRETE BLOCKOUT, PERFORMING ALL NECESSARY CONCRETE REPAIRS REQUIRED, TO MEET THE JOINT MANUFACTURER'S INSTALLATION REQUIREMENTS.
- 3. REMOVE ALL DEBRIS AND FOREIGN MATERIAL FROM THE CONCRETE BLOCKOUT WHICH MIGHT PREVENT PROPER INSTALLATION.


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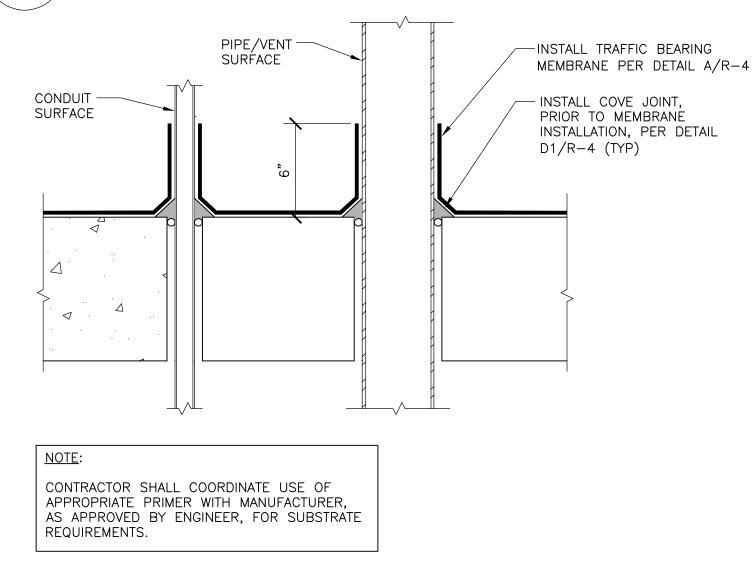
- 4. CONTRACTOR SHALL FIELD VERIFY ALL JOINT WIDTHS AND INSTALL THE APPROPRIATE SIZED EXPANSION JOINT GLAND AS PER MANUFACTURER'S RECOMMENDATIONS. ALL EXPANSION JOINT INSTALLATION DETAILS (I.E. BENDS, TURNS, TERMINATIONS, ETC.) SHALL BE PER MANUFACTURER'S STANDARD DETAILS AS APPROVED BY THE ENGINEER.
- 5. INSTALL SPECIFIED EXPANSION JOINT GLAND AS PER MANUFACTURER'S RECOMMENDATIONS. A CERTIFIED MANUFACTURER'S REPRESENTATIVE SHALL APPROVE OF CONCRETE BLOCKOUT PREPARATION, INSTALLATION PROCEDURES AND FINAL INSTALLATION IN WRITING.
- 6. CONTRACTOR SHALL NOTE THAT THE JOINT ELEMENTS SHALL BE A CONTINUOUS, FACTORY EXTRUDED UNIT FOR THE ENTIRE STRAIGHT RUN LENGTH OF THE JOINT, CONTINUING THROUGH CURBING AS REQUIRED.
- 7. THE SEAL ELEMENT SHALL NOT BE MITERED/JOINTED. CHANGES IN DIRECTION OR ELEVATION SHALL BE ACCOMPLISHED BY FACTORY SPLICING AND FACTORY MOLDED ELBOWS, TEES, CROSSES AND THE LIKE, AND SHALL NOT BE PERFORMED IN THE FIELD, UNLESS APPROVED BY THE ENGINEER. THE SEAL SHALL BE TURNED UP A MINIMUM OF 6 INCHES (VERTICALLY) UNLESS OTHERWISE SHOWN ON PLANS. ALL TERMINATIONS SHALL BE IN ACCORDANCE WITH MANUFACTURER'S RECOMMENDATIONS AND APPROVED BY THE ENGINEER SO AS TO PROVIDE A WATERTIGHT SEAL.

REPAIR PROCEDURE:


- 1. SHOTBLAST CLEAN HORIZONTAL SURFACES AND SANDBLAST CLEAN VERTICAL SURFACES SCHEDULED TO RECEIVE TRAFFIC BEARING WATERPROOFING MEMBRANE. OIL STAINS, PAINT AND OTHER CONTAMINANTS SHALL BE REMOVED AS RECOMMENDED BY THE SYSTEM
- 2. SURFACE PREPARATION SHALL ALSO INCLUDE REMOVING ANY EXISTING DETERIORATED MEMBRANE, GRINDING HIGH RIDGES IN THE EXISTING CONCRETE AND NEWLY CONSTRUCTED AREAS, WHICH MAY BE DETRIMENTAL TO THE SYSTEM PERFORMANCE. SYSTEM MANUFACTURER WILL BE EXPECTED TO ACCEPT FINAL DECK PREPARATION PRIOR TO MEMBRANE APPLICATION.
- ALL CRACKS GREATER THAN 1/16" AND CONTROL/CONSTRUCTION JOINTS SHALL BE ROUTED AND SEALED WITH AN APPROVED TWO-PART POLYURETHANE PER DETAILS D2 & D3/R-4. PLACE A 3/4" BY 3/4" COVE JOINT AT ALL INTERFACES BETWEEN HORIZONTAL AND VERTICAL SURFACES AS PER DETAIL D1/R-4.
- 3. THE SYSTEM MANUFACTURER AND COATING APPLICATOR SHALL PERFORM THE FOLLOWING:
- A. VERIFY THE MOISTURE CONTENT OF THE EXISTING AND NEW CONCRETE AREAS.
- B. PERFORM ADHESION TESTING ON EXISTING MEMBRANE AND NEW CONCRETE AREAS TO VERIFY COMPLIANCE WITH THE SYSTEM PERFORMANCE. DECK PREPARATION SHALL BE PER SPECIFICATION IN ALL TEST AREAS.
- C. THE SYSTEM MANUFACTURER AND COATING APPLICATOR SHALL SUBMIT A JOINT LETTER STATING THAT THE ABOVE TESTING WAS PERFORMED, THAT THE SURFACE PREPARATION IS ACCEPTABLE AND THAT THE SYSTEM WILL PERFORM PER SPECIFICATIONS, AS APPLIED ON THE
- 4. PROVIDE APPROPRIATE DETAILINGS, AS RECOMMENDED BY MANUFACTURER AND APPROVED BY ENGINEER.
- 5. APPLY THE APPROPRIATE (CONCRETE, METAL, ETC.) PRIMER PER MANUFACTURER'S RECOMMENDATIONS.
- 6. DETAIL CRACKS WITH BASE COAT(S) AS PER MANUFACTURER'S RECOMMENDED PROCEDURE.
- 7. APPLY BASE COAT TO SPECIFIED THICKNESS.
- 8. APPLY THE WEARING COURSE TO THE SPECIFIED THICKNESS AND COLOR. INSTALL MEMBRANE IN LAYERS, IF REQUIRED, AS PER MANUFACTURER'S RECOMMENDATION.
- 9. INSTALL THE LOCK COAT OR TOP COAT AS PER SYSTEM REQUIREMENTS.




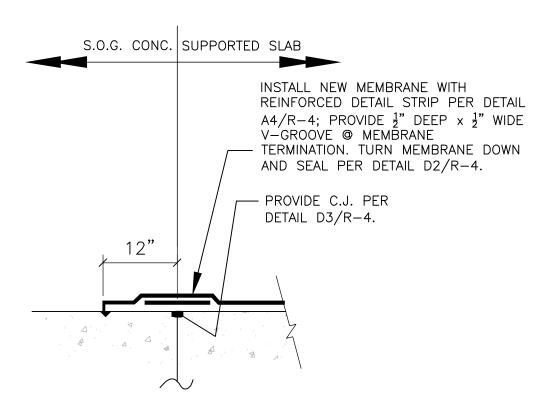


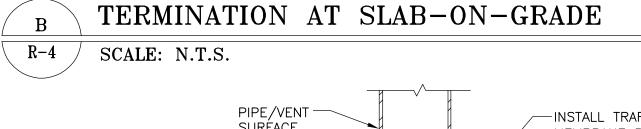



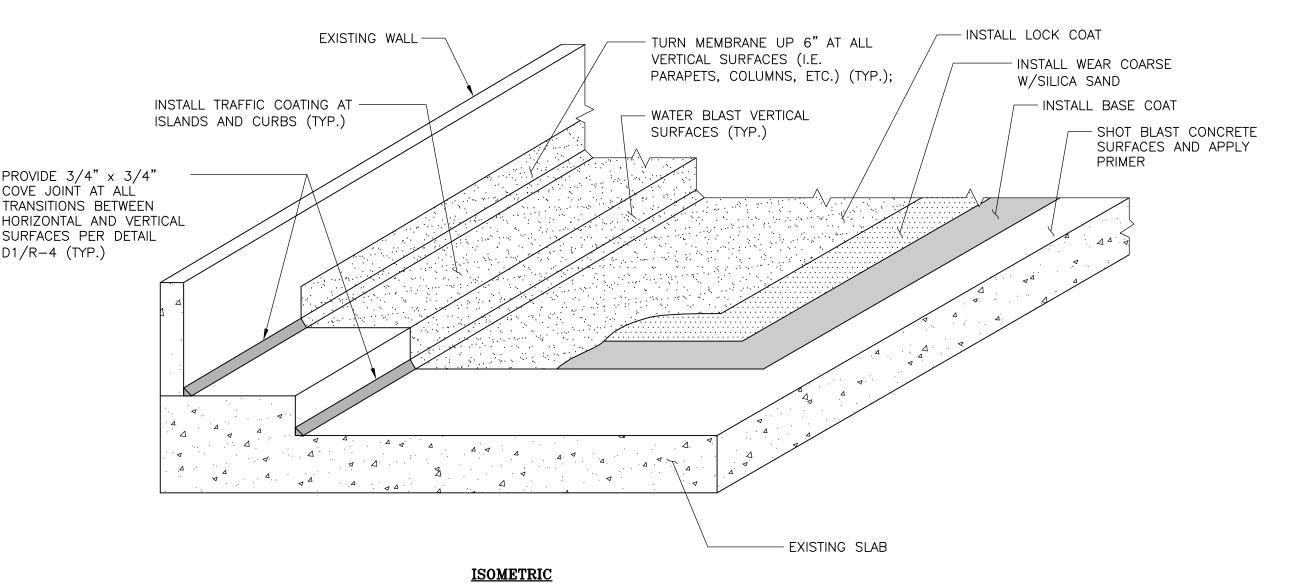

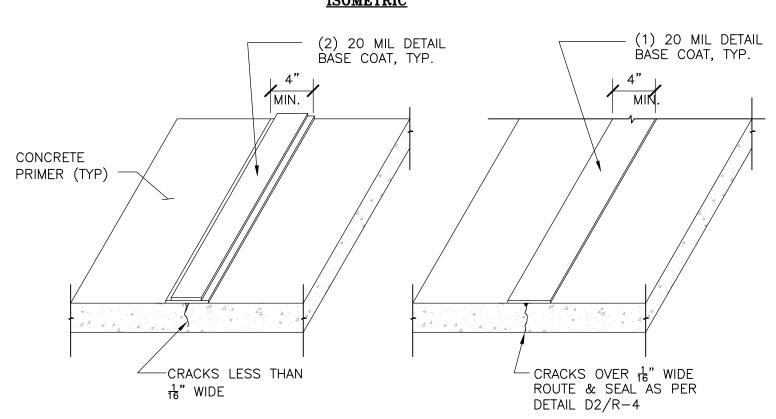


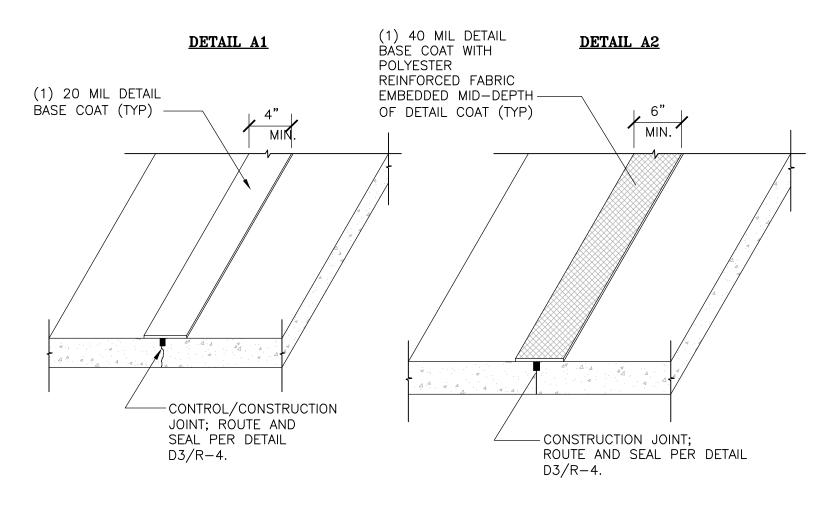

TRAFFIC BEARING MEMBRANE INSTALLATION / SCALE: N.T.S.


DETAIL A4

DETAIL A3

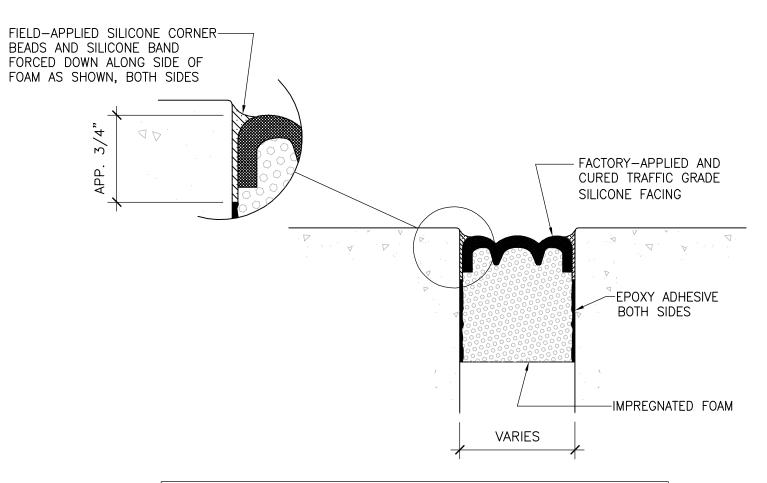

ACCEPTABLE JOINT SYSTEM: JOINT SYSTEM SHALL BE HSEAL, EH-SERIES, AS MANUFACTURED BY WATSON BOWMAN ACME, CORP., TEL: (716) 691-7566



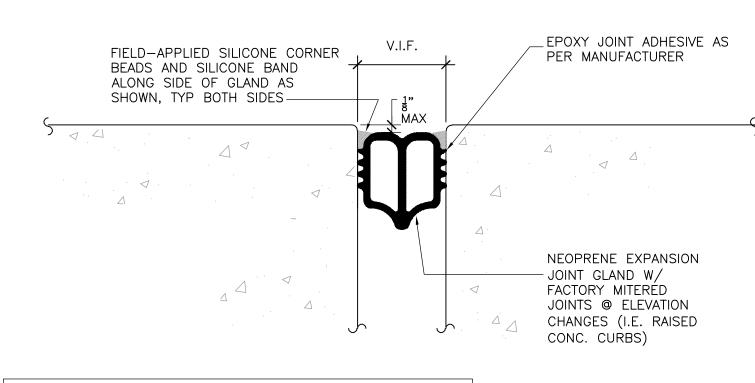

COVE JOINT AT ALL

D1/R-4 (TYP.)

ACCEPTABLE JOINT SYSTEM: JOINT SYSTEM SHALL BE JEENE, FW-SERIES, AS MANUFACTURED BY WATSON BOWMAN ACME, CORP., TEL: (716) 691-7566, OR APPROVED EQUAL

INSTALLATION OF NEW EPOXY-ADHERED, AIR-PRESSURIZED NEOPRENE EXPANSION JOINT SEAL R-4 / SCALE: N.T.S.

STATE OF CONNECTICUT WATERPROOFING **DETAILS AND SECTION** CAPITAL REGION DEVELOPMENT AUTHORITY Description APRIL 2021 AS NOTED oject Manager: CHURCH STREET PARKING GARAGE RENOVATIONS & IMPROVEMENTS HARTFORD, CONNECTICUT Drawing Number AD Number: Project Number: 21-016